

Sheet List Table			
Sheet Number	Sheet Title		
G-001	TITLE SHEET		
G-002	GENERAL NOTES AND LEGEND		
C-001	EXISTING CONDITIONS PLAN		
C-002	DEMOLITION AND REMOVALS PLAN		
C-101	LAYOUT PLAN		
C-102	SITE MATERIALS, PAVEMENT, AND STRIPING PLAN		
C-201	GRADING PLAN		
C-202	DRAINAGE PLAN AND UTILITY PLAN		
C-301	EROSION AND SEDIMENT CONTROL PLAN		
C-500	SITE DETAILS		
C-501	SITE DETAILS		
C-502	SITE DETAILS		
C-503	SITE DETAILS		
A101	PROPOSED FIRST FLOOR PLAN		
A202	PROPOSED ELEVATIONS		



GENERAL NOTES:

- DIG SAFE 811 OR 888-DIG-SAFE TOLL FREE.
- 3. THE CONTRACTOR IS INSTRUCTED TO COOPERATE WITH ANY AND ALL OTHER OF THIS CONTRACT.
- REPLACED AT THE CONTRACTOR'S EXPENSE.
- COMPLY WITH ALL REQUIRED PERMITS.
- REGULATIONS.
- GOVERNING THE INSTALLATION OF SUCH UTILITIES.
- AND INTERPRETED BY THE ENGINEER.
- REQUIRED TO MAKE THE WORK COMPLETE.

- 13. THE CONTRACTOR SHALL:

- EXISTING CONDITIONS ON THE WORK.

- PROFESSIONAL ENGINEER.
- CONNECTION TO EXISTING SYSTEMS IS MADE.
- 18. MAINTAIN FLOW FOR ALL EXISTING UTILITIES.
- SHALL BE 0.1' ABOVE GRADE.
- BE ACCEPTED.

- EACH WORK DAY.
- CONTRACTOR'S EXPENSE.

1. THE PLANS SHOW SUBSURFACE STRUCTURES, ABOVE GROUND STRUCTURES AND/OR UTILITIES FROM FIELD LOCATION AND RECORD MAPPING, EXACT LOCATION OF WHICH MAY VARY FROM THE LOCATIONS INDICATED. IN PARTICULAR, THE CONTRACTOR IS WARNED THAT THE EXACT OR EVEN APPROXIMATE LOCATION OF SUCH PIPELINES, SUBSURFACE STRUCTURES AND/OR UTILITIES IN THE AREA MAY BE DIFFERENT FROM THAT SHOWN OR MAY NOT BE SHOWN, AND IT SHALL BE HIS RESPONSIBILITY TO PROCEED WITH GREAT CARE IN EXECUTING ANY WORK. 48 HOURS BEFORE YOU DIG, DRILL, OR BLAST, CALL

2. THE ENGINEER SHALL BE NOTIFIED IN WRITING OF ANY CONDITIONS THAT VARY FROM THOSE SHOWN ON THE PLANS. THE CONTRACTOR'S WORK SHALL NOT VARY FROM THE PLANS WITHOUT THE EXPRESSED APPROVAL OF THE ENGINEER.

CONTRACTORS PERFORMING WORK ON THIS JOB SITE DURING THE PERFORMANCE

4. THE CONTRACTOR SHALL RESTORE LAWNS, DRIVEWAYS, CULVERTS, SIGNS AND OTHER PUBLIC OR PRIVATE PROPERTY DAMAGED OR REMOVED TO AT LEAST AS GOOD A CONDITION AS BEFORE BEING DISTURBED AS DETERMINED BY THE ENGINEER. ANY DAMAGED TREES, SHRUBS, AND/OR HEDGES SHALL BE

5. PRIOR TO COMMENCEMENT OF STORM AND/OR SANITARY SEWER CONSTRUCTION, CONTRACTOR IS TO VERIFY BOTH HORIZONTAL AND VERTICAL POSITION OF EXISTING SEWER AT CONNECTION POINT. CONTRACTOR IS TO CONSTRUCT GRAVITY LINES PROGRESSIVELY FROM DOWNSTREAM TO UPSTREAM. ANY EXCEPTIONS TO THIS MUST BE APPROVED BY THE ENGINEER. ANY GRADE DISCREPANCIES MUST BE BROUGHT TO THE ENGINEERS ATTENTION IMMEDIATELY.

6. THE CONTRACTOR SHALL BE RESPONSIBLE FOR OBTAINING AND INCURRING THE COST OF ALL REQUIRED PERMITS, INSPECTIONS, CERTIFICATES, ETC. AND SHALL

7. ALL WORK SHALL BE DONE IN STRICT COMPLIANCE WITH ALL APPLICABLE NATIONAL, STATE, AND LOCAL CODES, STANDARDS, ORDINANCES, RULES, AND

8. ALL PROPOSED UTILITIES AND APPURTENANCES TO BE CONSTRUCTED IN COMPLIANCE WITH THE LOCAL MUNICIPALITIES' CODES AND REGULATIONS

9. THE ENGINEER RESERVES THE RIGHT TO EXAMINE ANY WORK DONE ON THIS PROJECT AT ANY TIME TO DETERMINE THE CONFORMANCE WITH THE REQUIREMENTS OF THE CONTRACT DOCUMENTS OF THIS PROJECT, AS INTENDED

10. MISCELLANEOUS WORK NOT SPECIFICALLY SHOWN ON THE CONTRACT DRAWINGS SUCH AS PATCHING, BLOCKING, TRIMMING, ETC., SHALL BE PERFORMED AS

11. THE CONTRACTOR SHALL PROTECT EXISTING PROPERTY LINE MONUMENTATION. ANY MONUMENTATION DISTURBED OR DESTROYED, AS JUDGED BY THE ENGINEER OR OWNER. SHALL BE REPLACED AT THE CONTRACTOR'S EXPENSE UNDER THE SUPERVISION OF A MAINE STATE LICENSED LAND SURVEYOR.

12. IT IS THE CONTRACTOR'S RESPONSIBILITY TO EXAMINE ALL PLAN SHEETS AND COORDINATE WORK WITH ALL OTHER CONTRACTS FOR THE SITE.

A. VERIFY ALL CONDITIONS IN THE FIELD PRIOR TO COMMENCEMENT OF WORK AND NOTIFY THE ENGINEER OF ANY DISCREPANCIES. B. EXAMINE THE SITE AND INCLUDE IN HIS WORK THE EFFECT OF ALL

C. PROVIDE AND INSTALL ALL MATERIALS AND PERFORM ALL WORK IN ACCORDANCE WITH RECOGNIZED GOOD STANDARD PRACTICE. D. HOLD THE OWNER HARMLESS AGAINST ANY AND ALL CLAIMS ARISING FROM WORK DONE BY THE CONTRACTOR ON THE SITE.

14. ALL TRENCH EXCAVATION AND ANY REQUIRED SHEETING AND SHORING SHALL BE DONE IN ACCORDANCE WITH MAINE STATE REGULATIONS FOR CONSTRUCTION. SHEET PILING SHALL BE DESIGNED AND SEALED BY A MAINE STATE

15. CONTRACTOR SHALL BE RESPONSIBLE FOR DEWATERING AND THE MAINTENANCE OF SURFACE DRAINAGE DURING THE COURSE OF WORK AND SHALL SUBMIT A DEWATERING PLAN DESIGNED AND SEALED BY A MAINE STATE PROFESSIONAL ENGINEER. CONTRACTOR SHALL MAINTAIN EXISTING SITE DRAINAGE PATTERNS THROUGHOUT CONSTRUCTION UNLESS OTHERWISE SHOWN ON THE PLANS.

16. ALL UTILITY WORK INVOLVING CONNECTIONS TO EXISTING SYSTEMS SHALL BE COORDINATED WITH THE ENGINEER AND THE UTILITY OWNER. NOTIFY THE ENGINEER AND THE UTILITY OWNER 72 HOURS BEFORE EACH AND EVERY

17. CONSTRUCTION OF ALL PROPOSED UTILITIES MUST BEGIN AT ITS POINT OF CONNECTION TO THE EXISTING UTILITY OR AT THE LOWEST POINT IN THE SYSTEM. RIMS, GRATES, INVERTS, CLEARANCES, AND LOCATION AT CROSSINGS MUST BE VERIFIED PRIOR TO THE BEGINNING OF CONSTRUCTION.

19. ALL FRAMES/COVERS WITHIN PAVED AREAS SHALL HAVE THE TOPS SET FLUSH WITH THE EXISTING PAVEMENT GRADE. IN LANDSCAPED AREAS, ALL FRAMES

20. THE CONTRACTOR SHALL BE RESPONSIBLE FOR PROVIDING ALL FIELD LAYOUT. THE CONTRACTOR SHALL TAKE TIES TO ALL UTILITY CONNECTIONS AND PROVIDE MARKED-UP AS-BUILT PLANS FOR ALL UTILITIES SHOWING TIES TO CONNECTIONS, BENDS, VALVES, LENGTHS OF LINES, AND INVERTS. AS-BUILT PLANS SHOWING ALL UNDERGROUND UTILITIES INSTALLED OR ENCOUNTERED SHALL BE REVIEWED BY THE OWNER AND HIS REPRESENTATIVES. THE CONTRACTOR SHALL PROVIDE ANY CORRECTION OR ADMISSIONS TO THE SATISFACTION OF THE OWNER AND HIS REPRESENTATIVES BEFORE UTILITIES WILL

21. TEMPORARY PAVEMENT SHALL BE PLACED WITHIN 48 HOURS OF COMPLETION OF EXCAVATION AND BACKFILL OPERATIONS WITHIN THE EXISTING PAVEMENT LIMITS.

22. CONTRACTOR SHALL MAINTAIN ALL TRAFFIC IN ALL AREAS IN ACCORDANCE WITH THE MAINEDOT MANUAL OF UNIFORM TRAFFIC CONTROL DEVICES.


23. ALL EXCAVATIONS SHALL BE BACKFILLED TO EXISTING GRADE AT THE END OF


24. CONTRACTOR SHALL TAKE CARE TO PREVENT DAMAGE TO EXISTING UTILITIES. DAMAGED UTILITIES SHALL BE IMMEDIATELY REPAIRED BY CONTRACTOR AT THE


	LEGEND	
DESCRIPTION	EXISTING	PROPOSED
FENCE	XX	× × × × ×
5' OR 10' CONTOUR LINE	250	250
1' OR 2' CONTOUR LINE	202	202
SPOT ELEVATION	120.5 OR _x 120.5	120.5 OR _x 120.5
DITCH OR SWALE		~~ •
EDGE OF STREAM OR RIVER		
LAKE OR POND		
PROPERTY LINE		
SILT FENCE		SF
GRADING LIMITS		
EDGE OF PAVEMENT		
CURB		
EDGE OF GRAVEL/DIRT ROAD		
EDGE OF WOODS		
BUILDING		
STORM SEWER	(TYPE) STORM SEWER	
SANITARY SEWER	(TYPE) SANITARY SEWER	<u>_</u>
FORCE MAIN		
WATER LINE	(TYPE) WATER LINE W	·····
GAS LINE		— — — GAS — — —
	UNDERGROUND ELECTRIC	
UNDERGROUND TELEPHONE	UNDERGROUND TELEPHONE	
OVERHEAD TELEPHONE	OVERHEAD WIRES	
OVERHEAD ELECTRIC	OVERHEAD WIRES	
	۲	UD
OBJECT FREE AREA (OFA)		
RUNWAY SAFETY AREA (RSA) BARRICADE		
	0000	
GUIDE RAIL		
	0	
END SECTION	>	
CATCH BASIN		
STORM MANHOLE	0	₩
	-\$-	
WATER VALVE/CONTROL VALVE	و	•
SPRINKLER HEAD		
SANITARY SEWER		(S) OR
PULL BOX		
TELEPHONE PEDESTAL		PB
ELECTRIC BOX		
ELECTRIC MANHOLE		E
LIGHT POLE, LAMP POST	-0	*
POWER POLE / UTILITY POLE	×.	N
RUNWAY/TAXIWAY EDGE LIGHT	÷.	


LEGEND (CONTINUED)					
DESCRIPTION	EXISTING	PROPOSED			
RWY/TWY CENTERLINE LIGHT	*				
SIGN – SINGLE FACED		• OR •••			
SIGN – DOUBLE FACED	H				
RWY/TWY SIGN	Ū				
RWY/TWY SIGN BASE ONLY	D				
MARKER					
CONCRETE MONUMENT	X				
RIGHT-OF-WAY MONUMENT	۵				
IRON ROD, PIN, OR PIPE	o	o			
BORING LOCATION	- ∲ - B−1	+			
CBR LOCATION	- CBR-1	+CBR			
WINDSOCK	\triangleright				
WETLAND/MARSH	عنائد عنائد منائد عنائد	(<u>*</u> *			
TREES, SHRUBS, BUSHES		XX-3 (0,00) XX-5			
DETAIL CALLOUT	X DETAIL IDENTIFICATION NO. X-X SHEET NO. WHERE DETAIL IS SHOWN				
DETAIL IDENTIFICATION NO.	X DETAIL TITLE				
NOTE: SOME FEATURE	S IN THE LEGEND MAY NOT H	AVE BEEN USED			




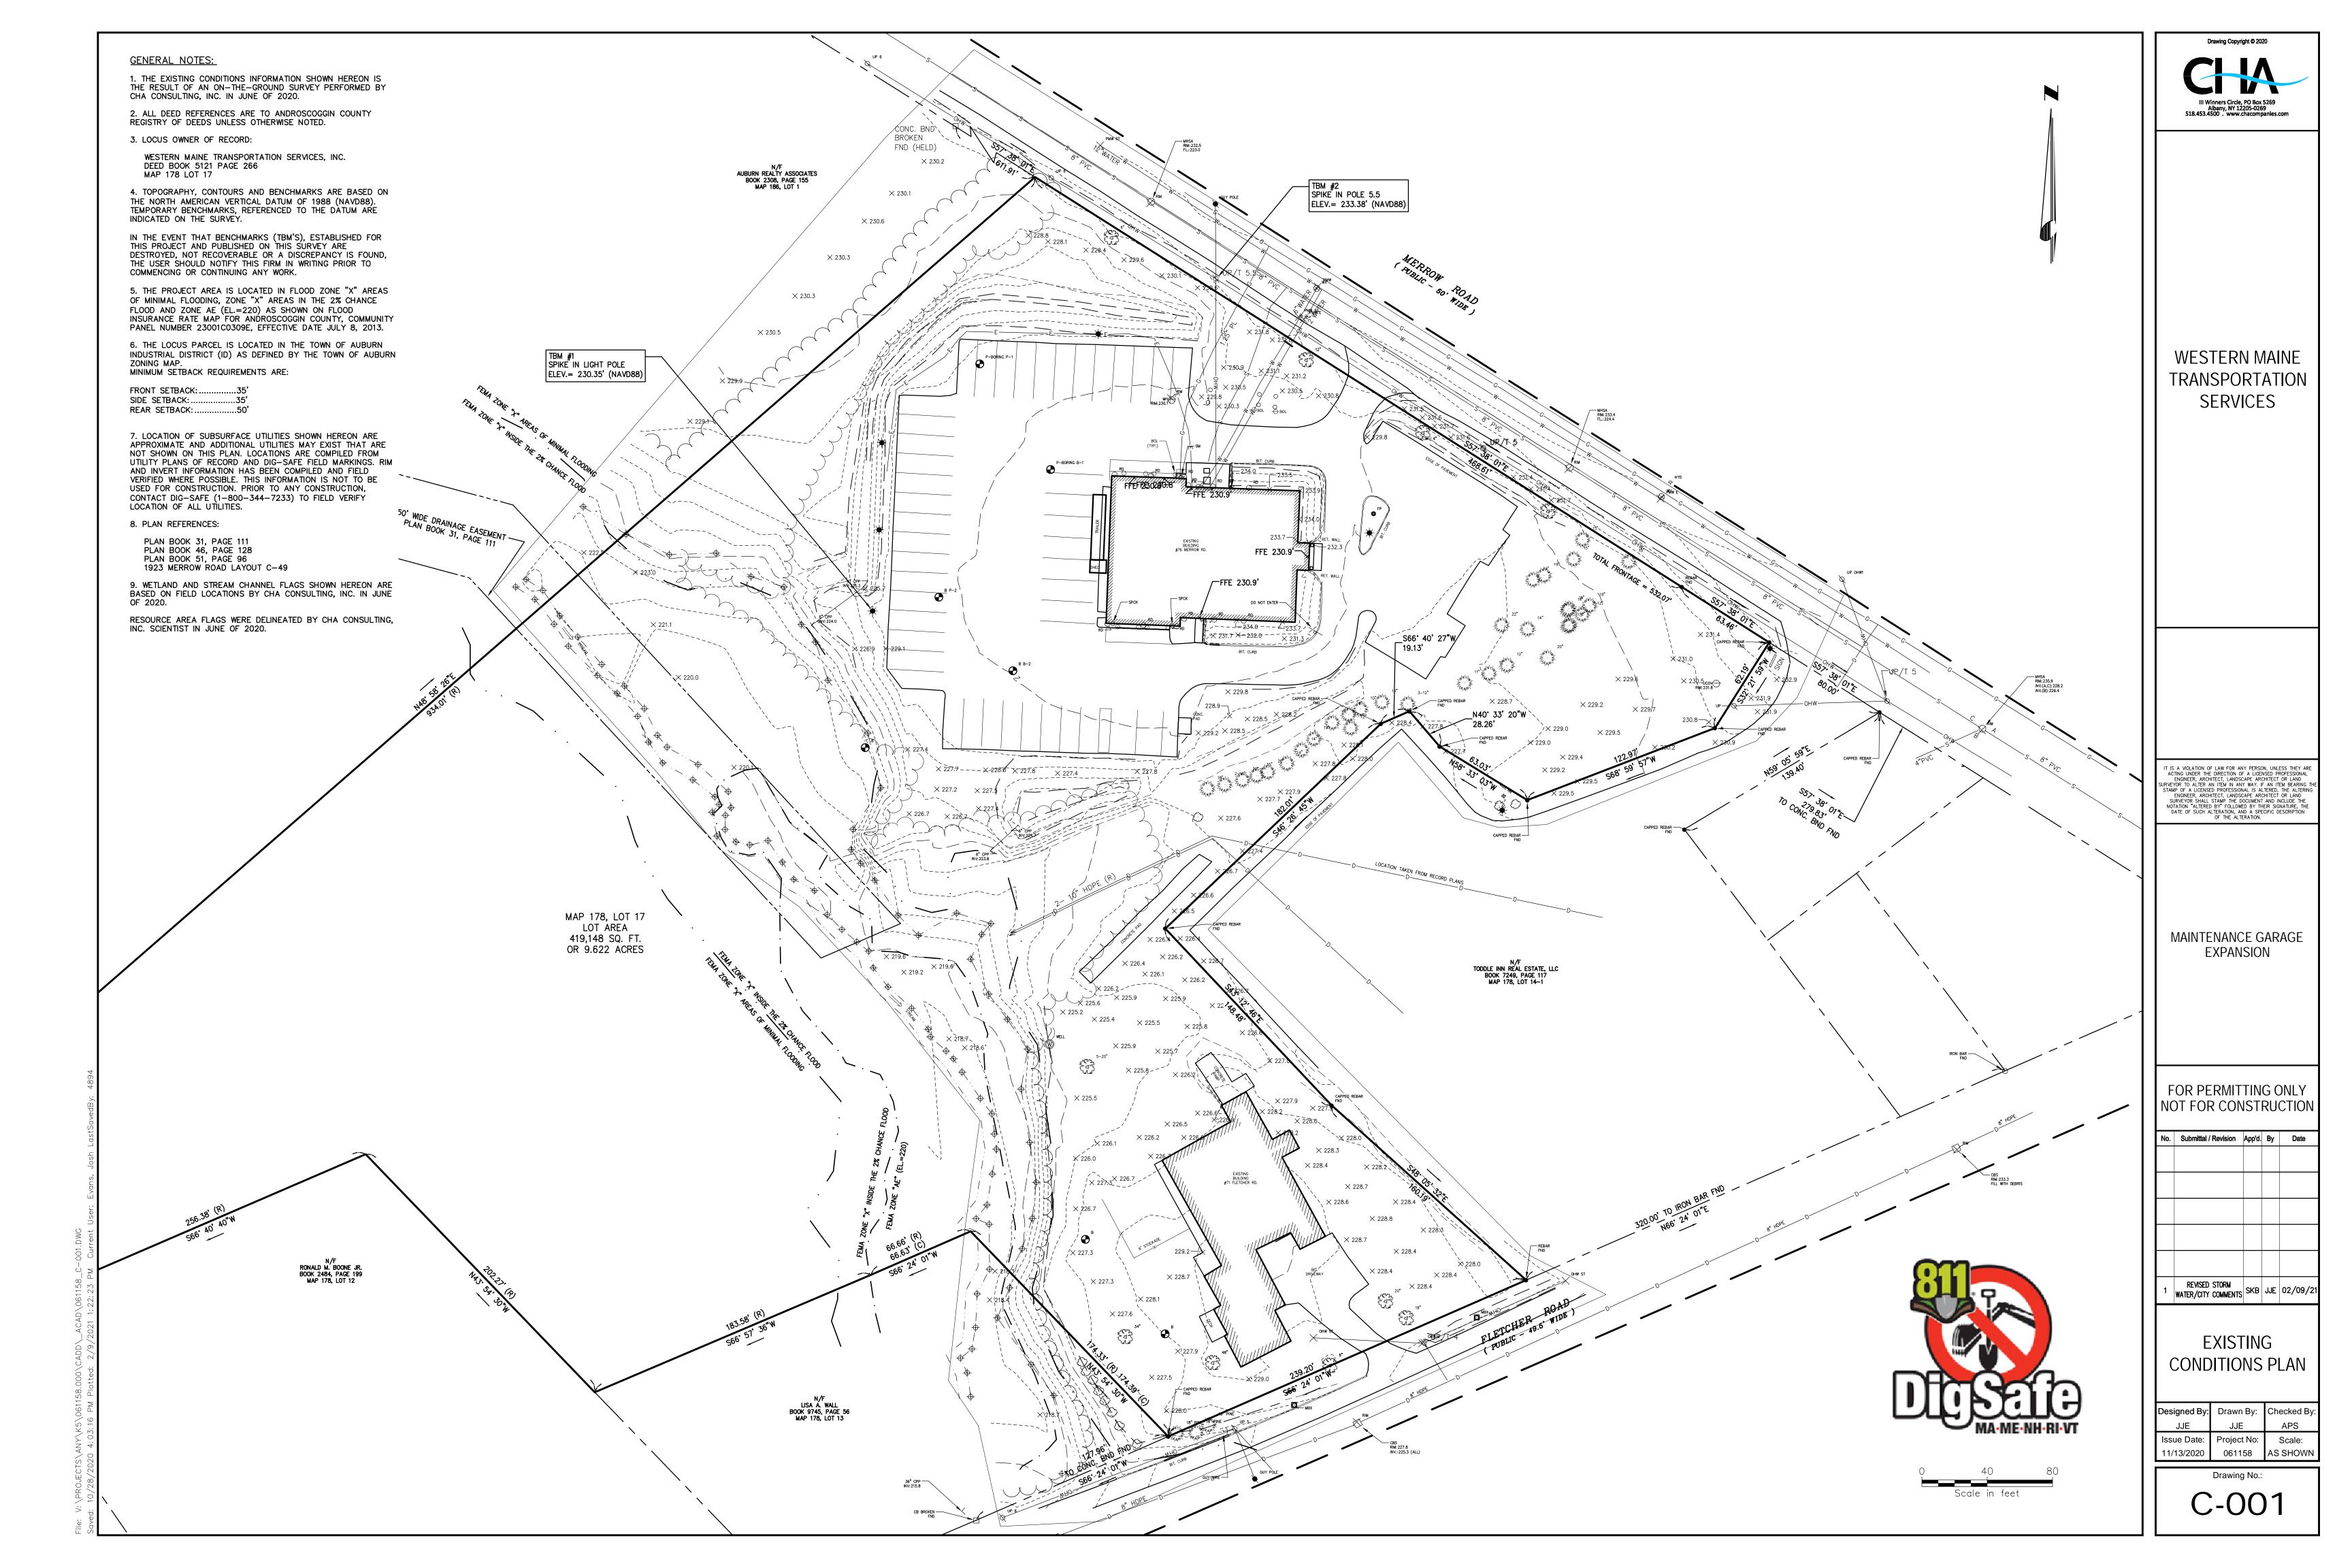

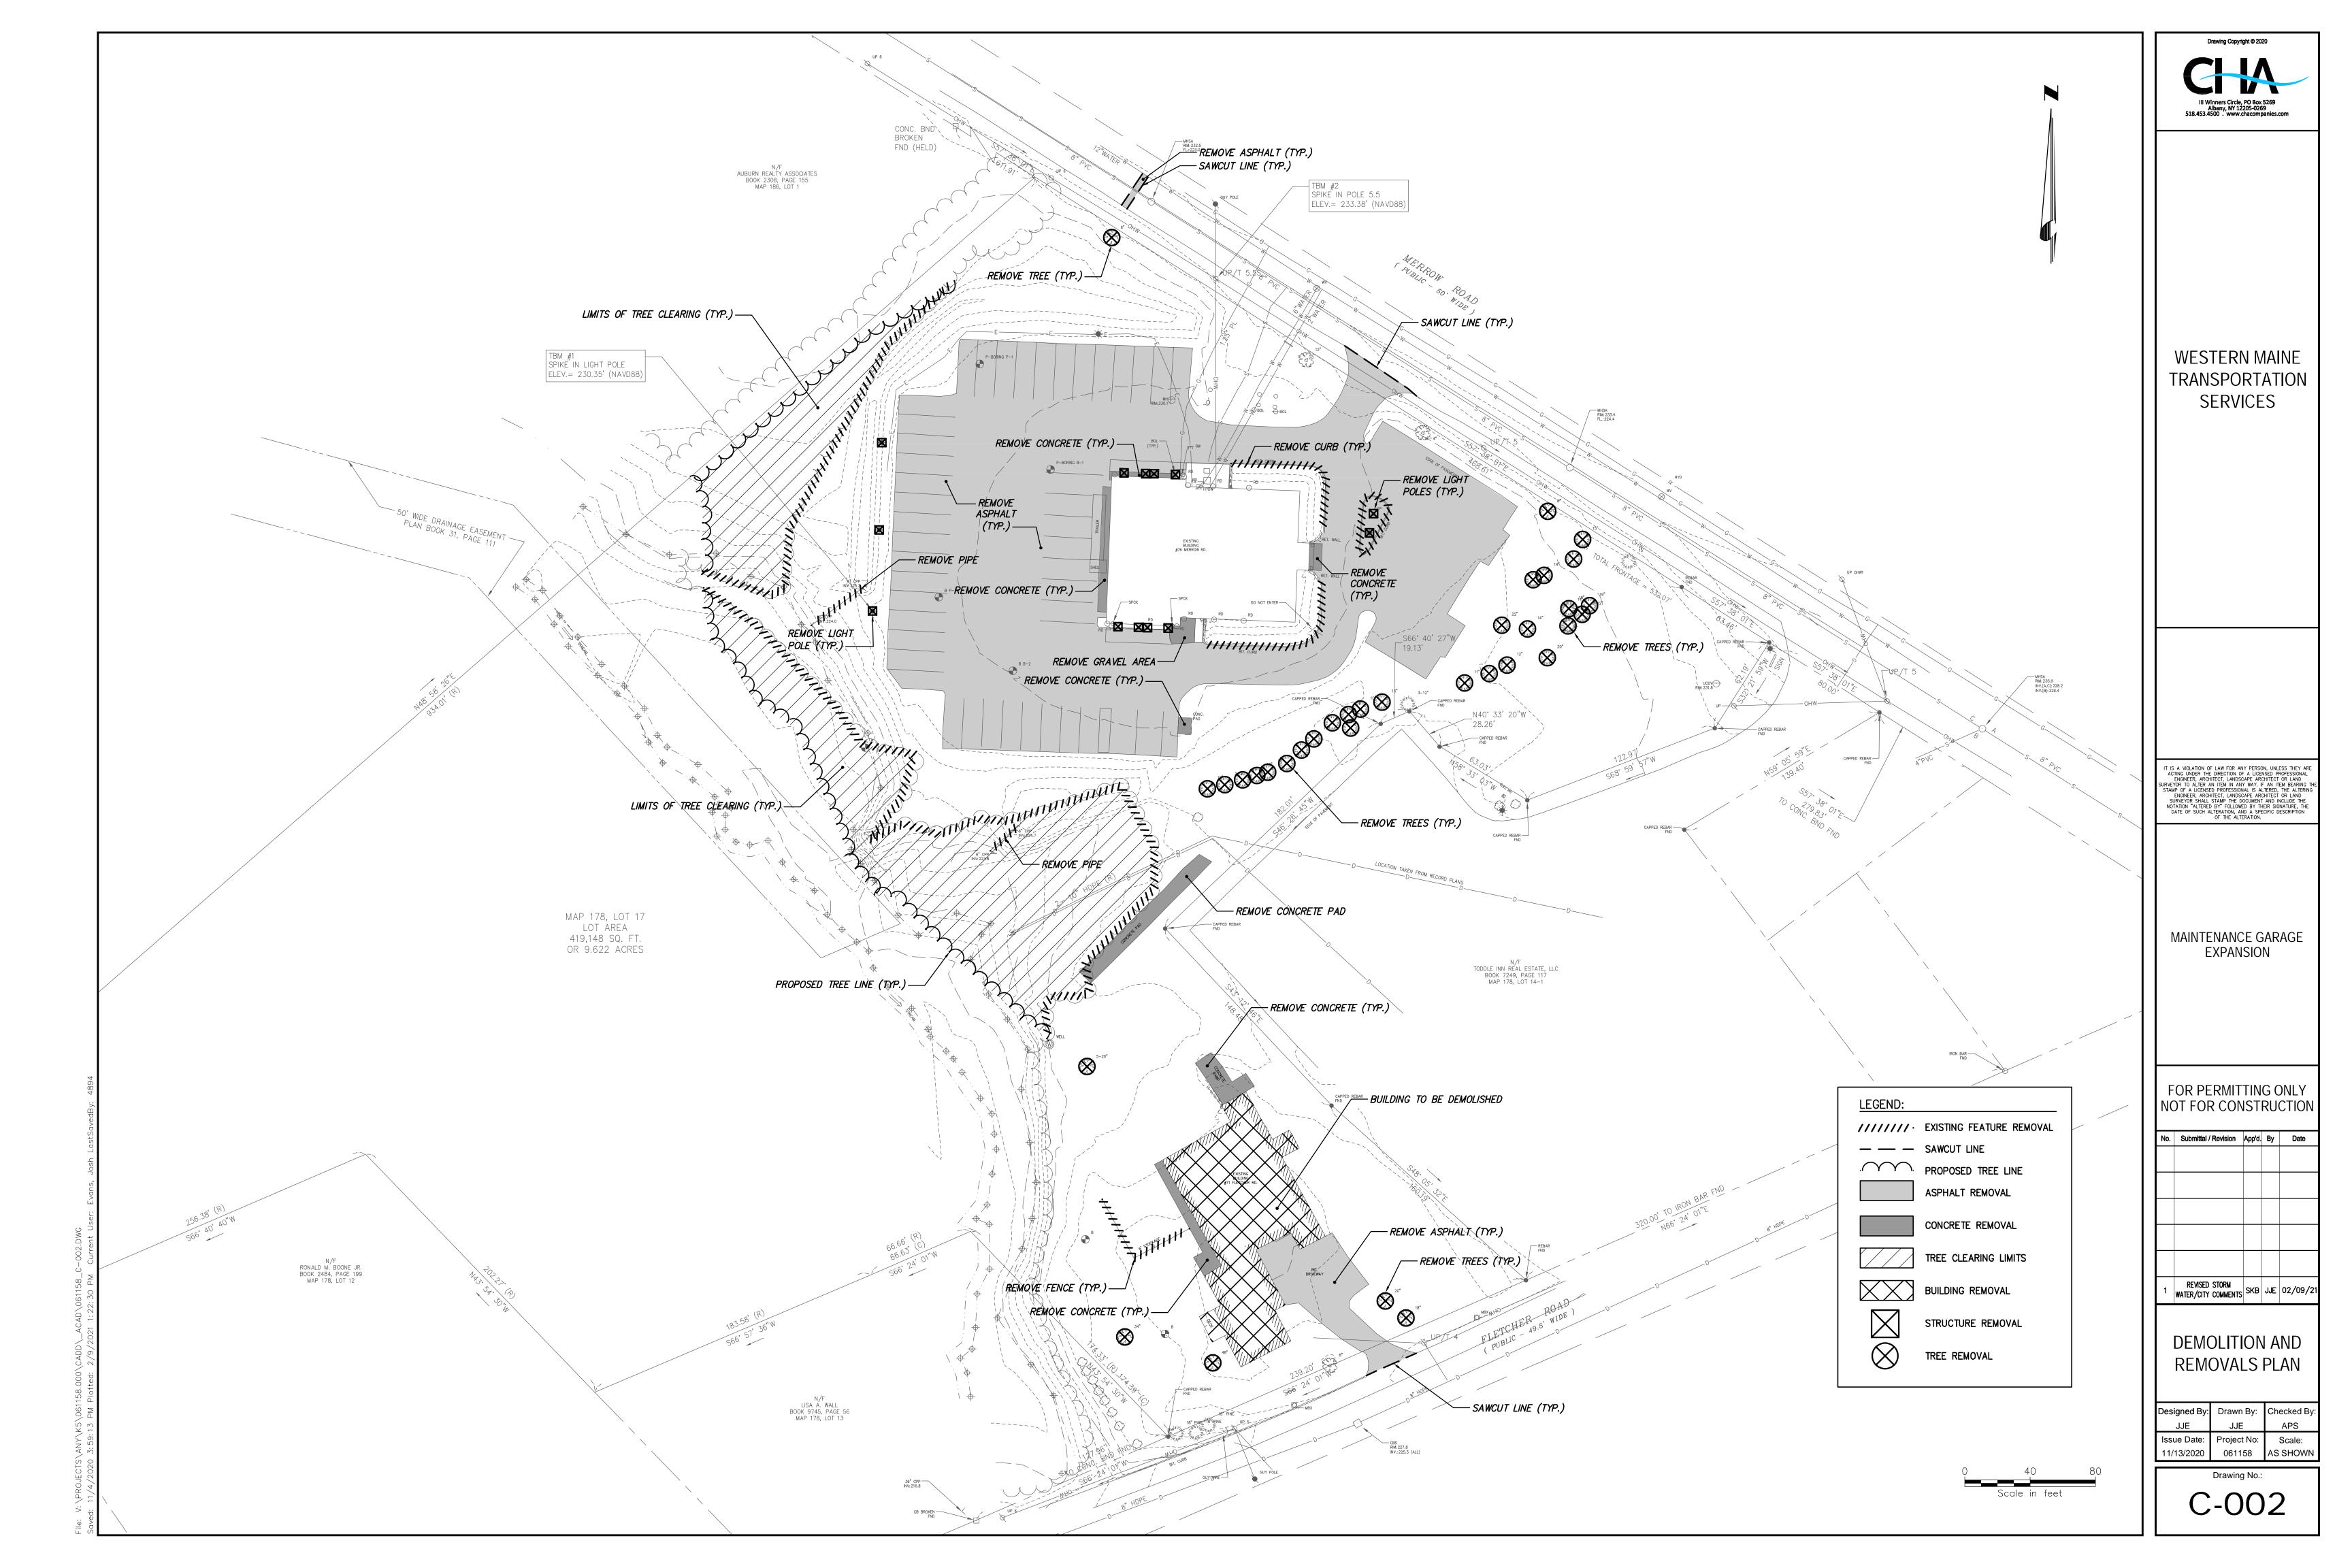


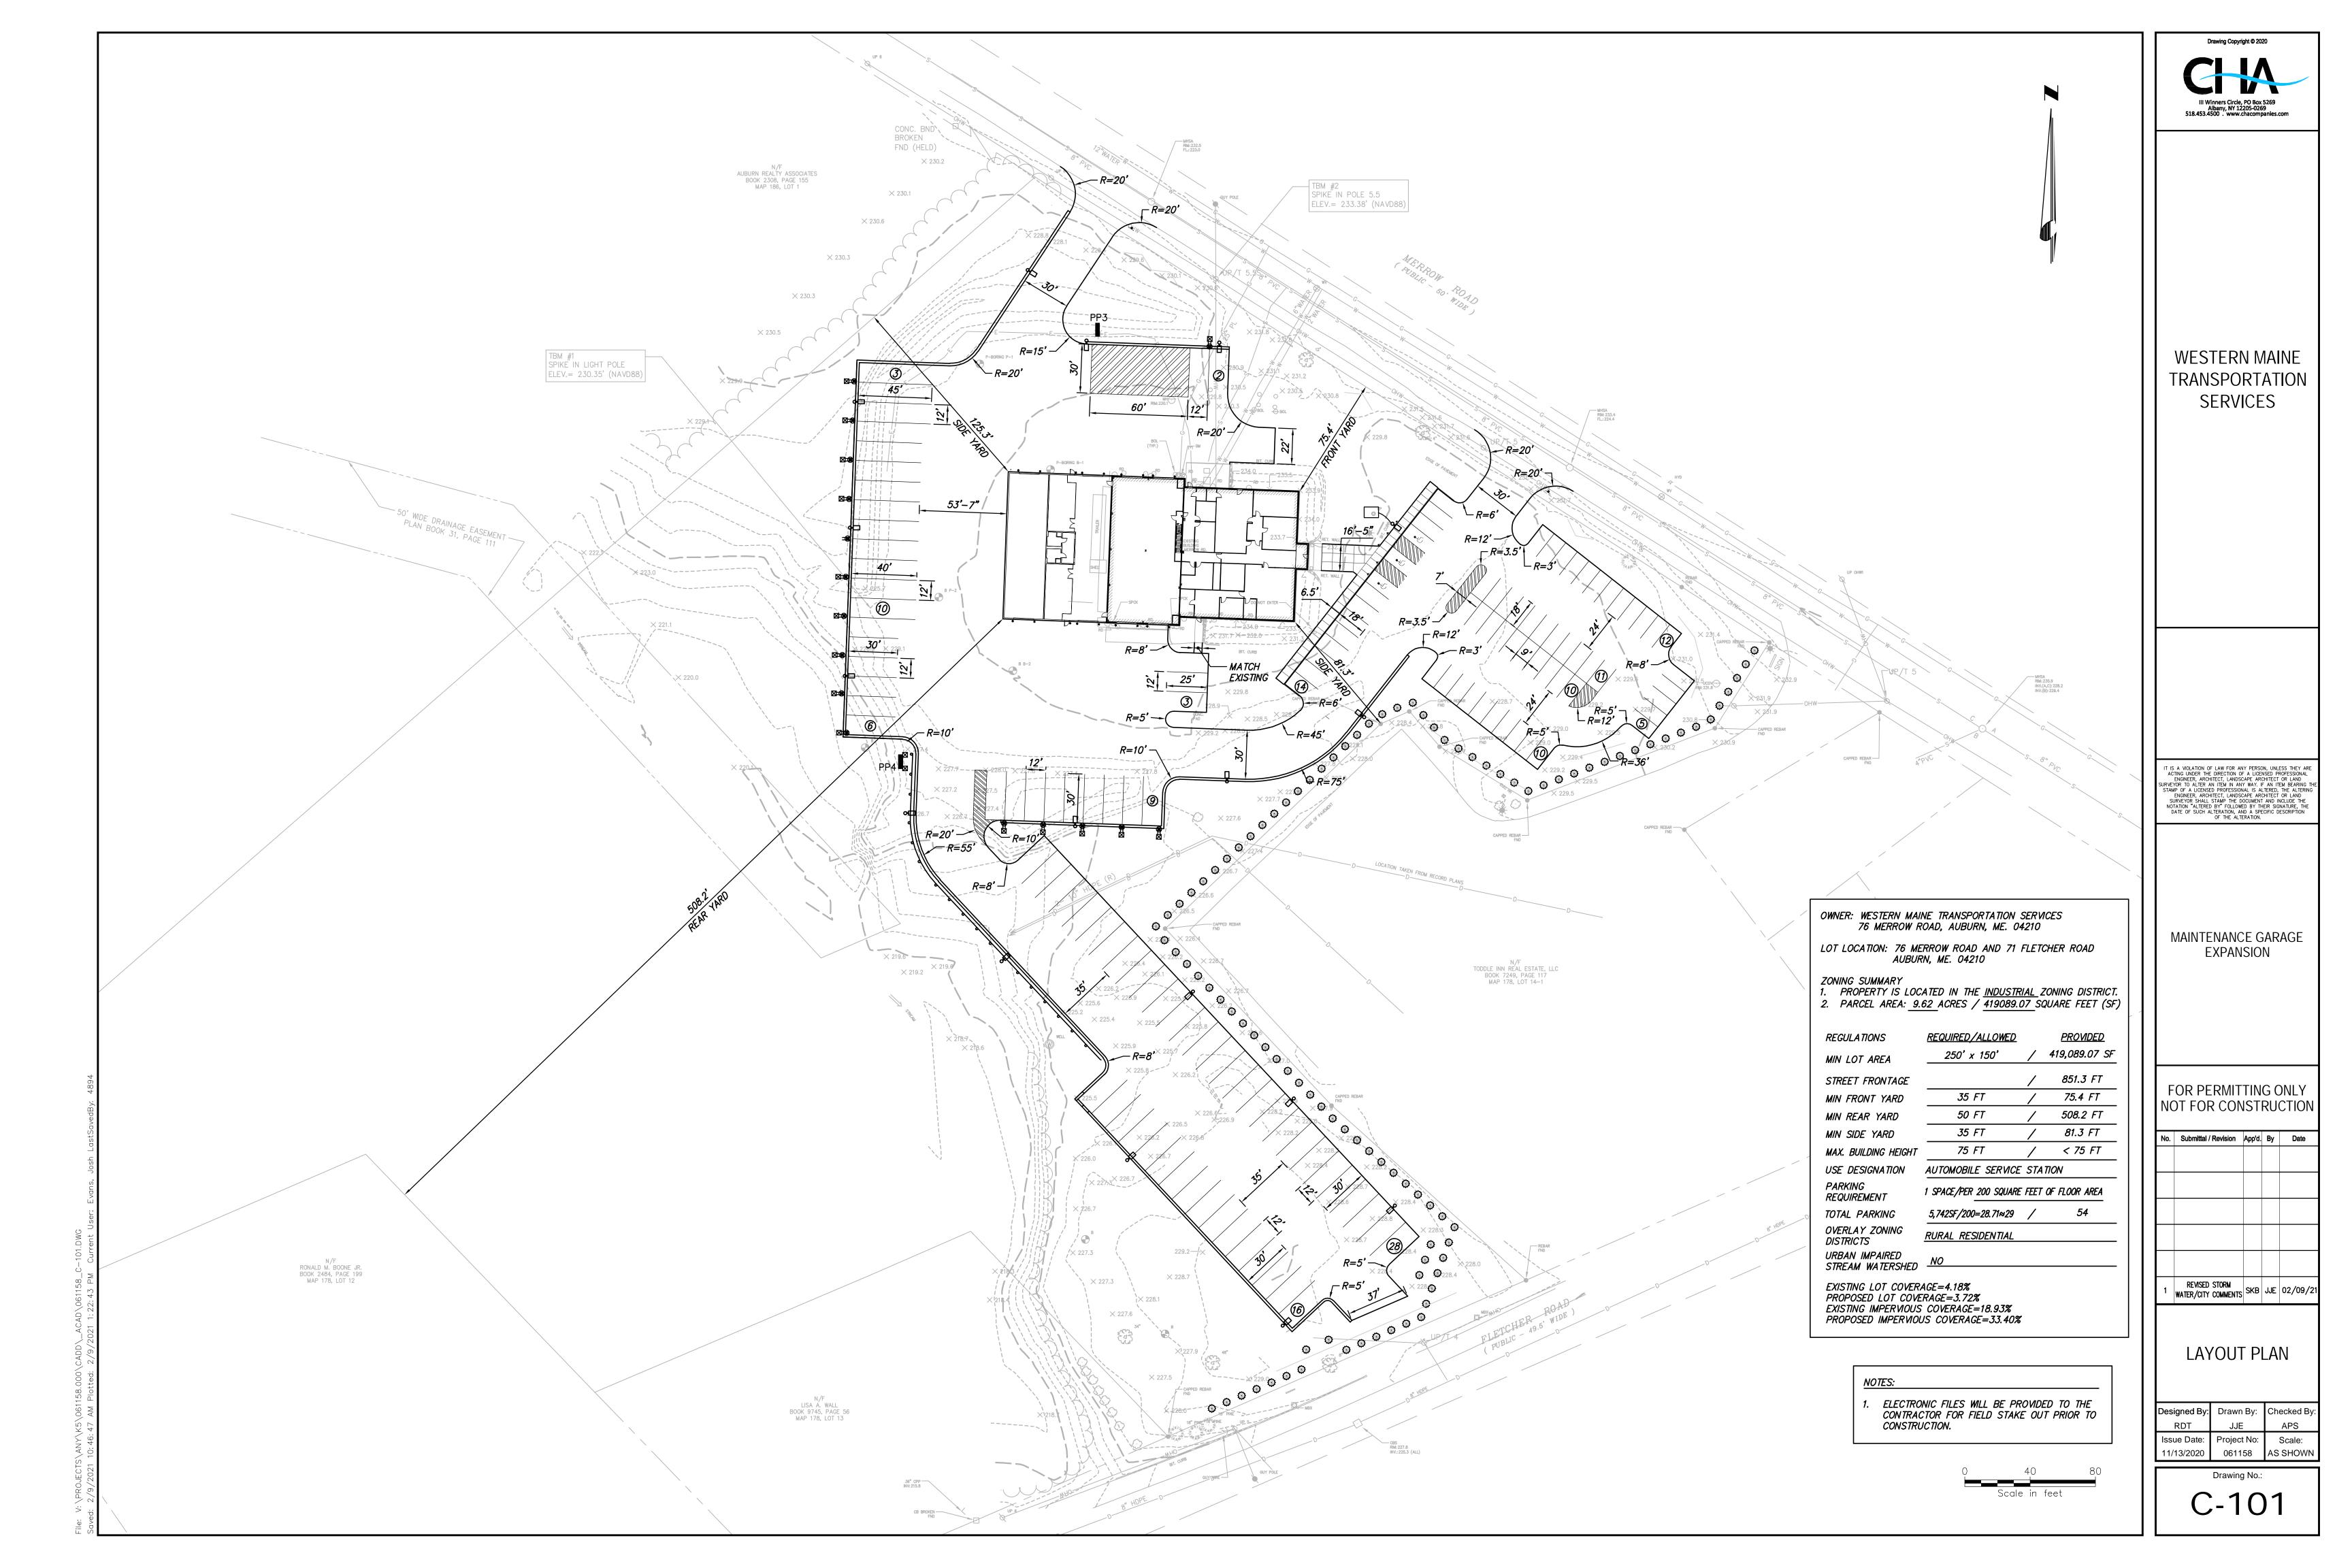


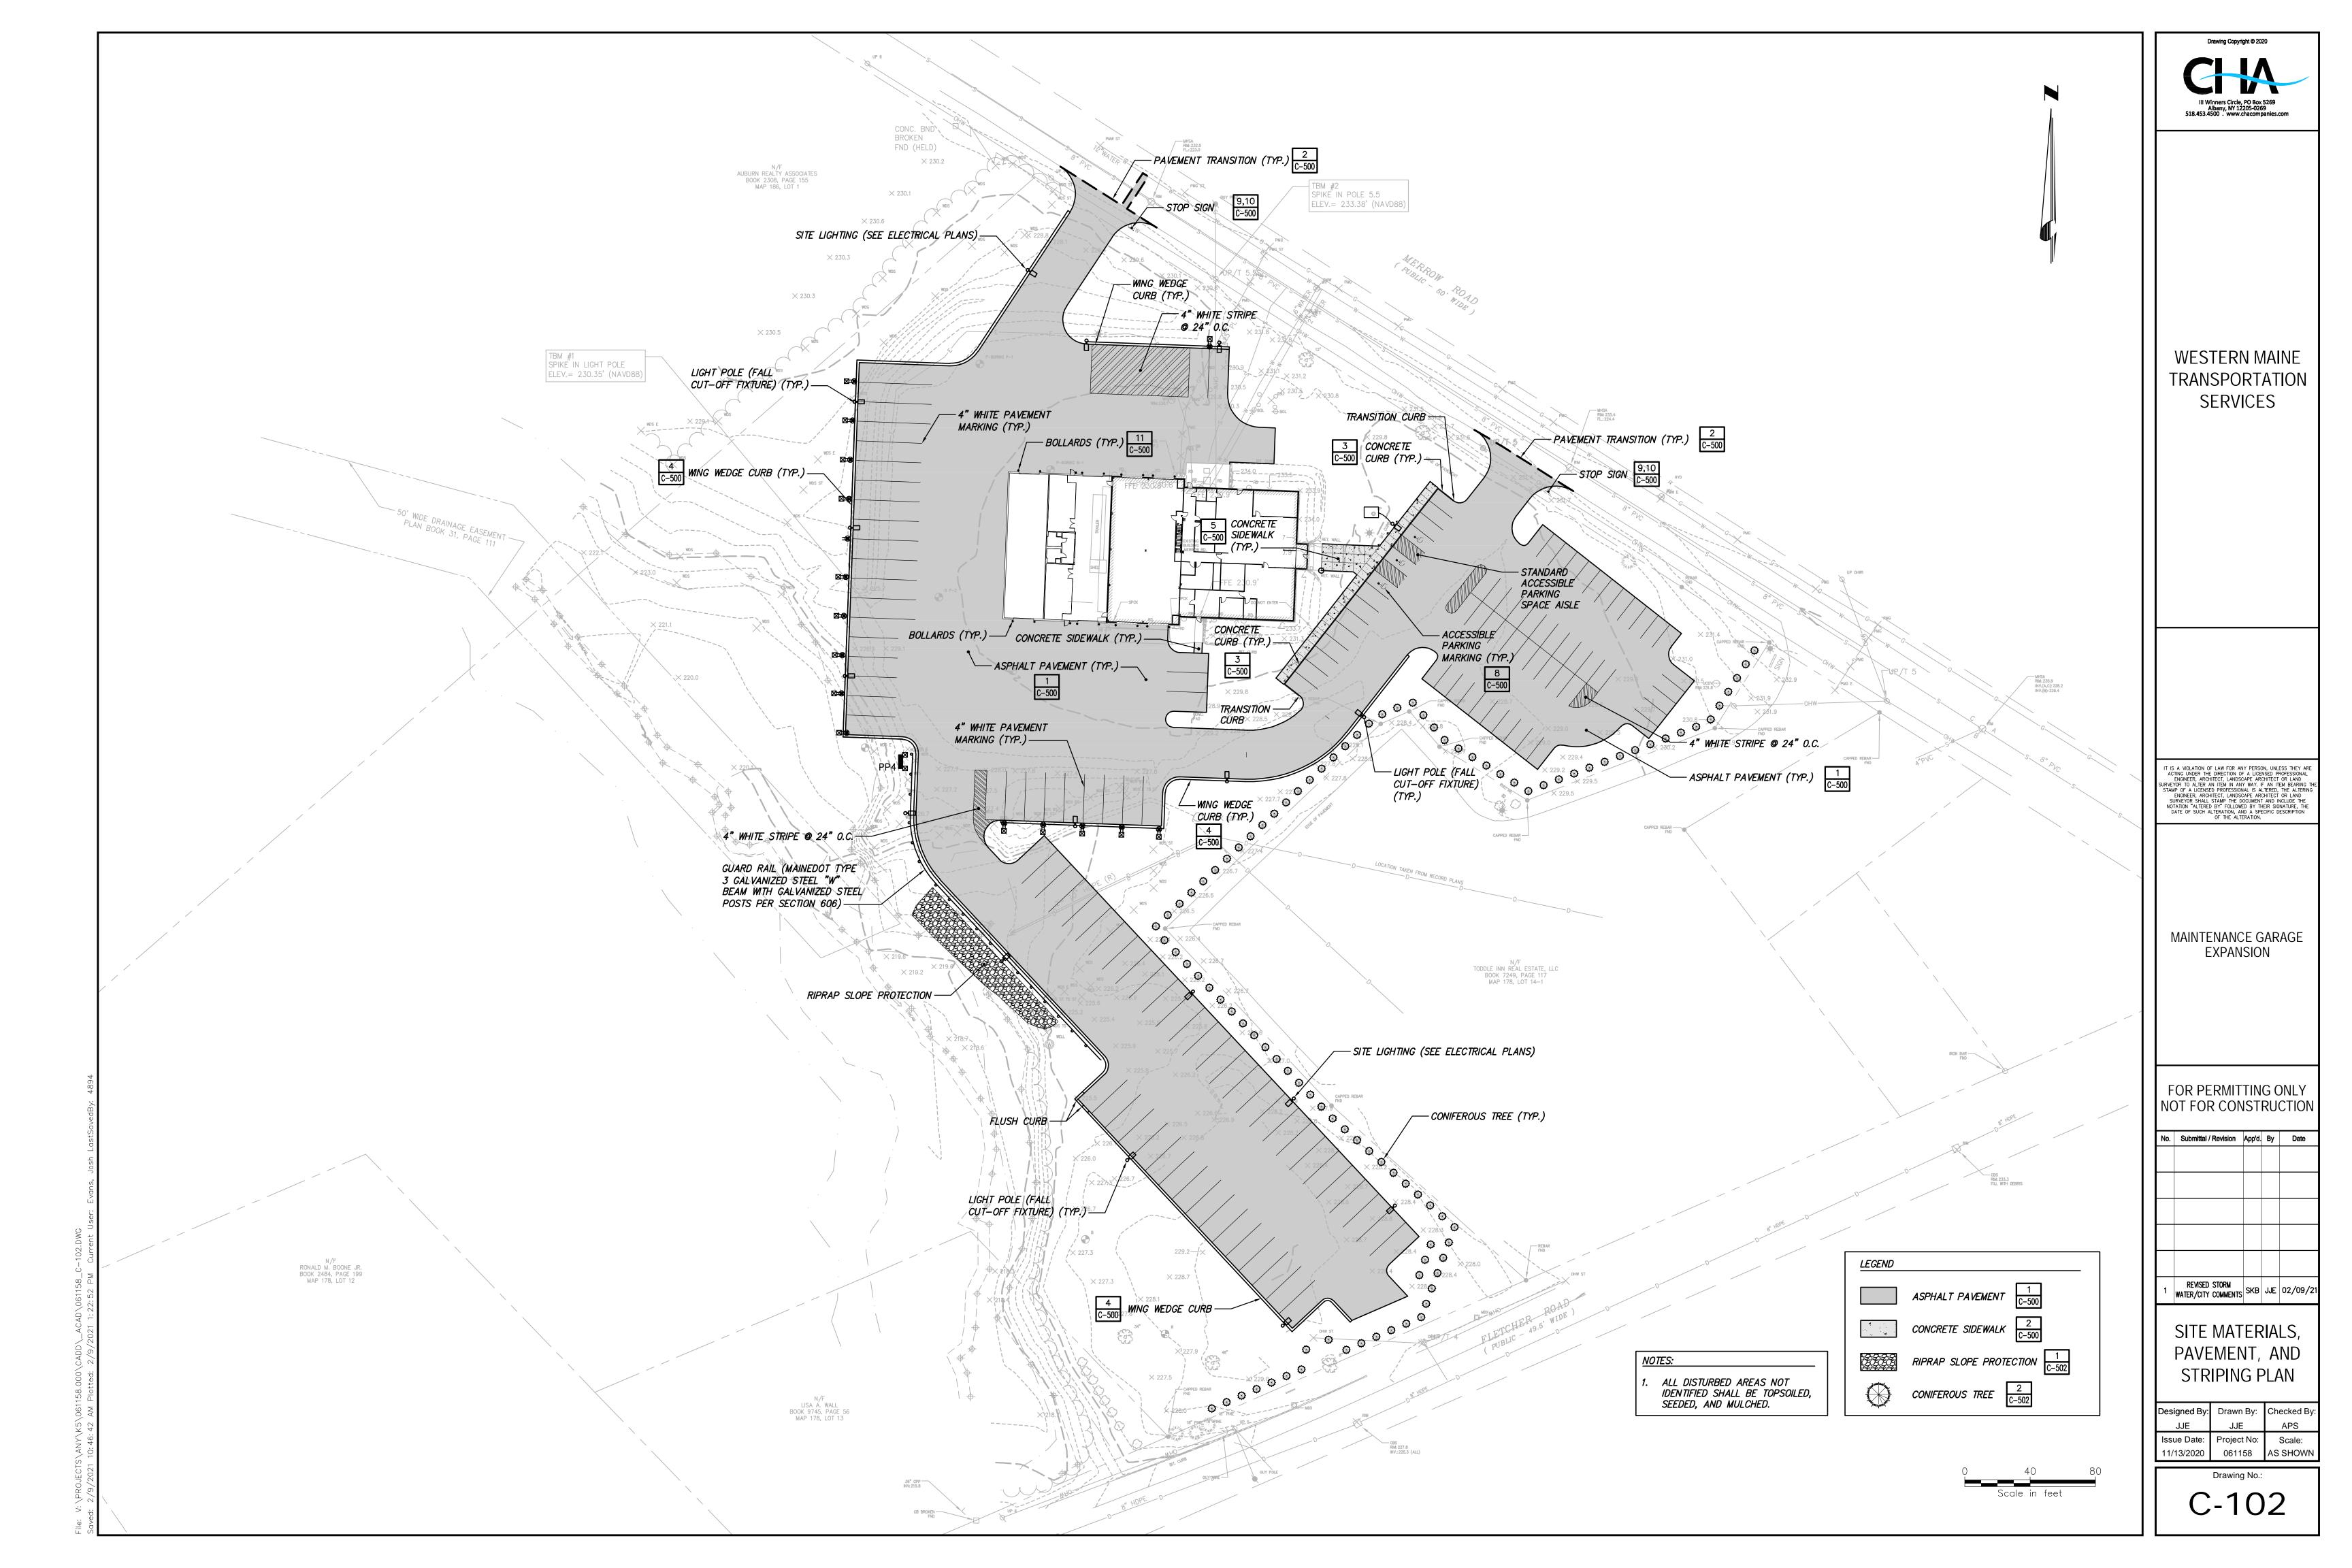


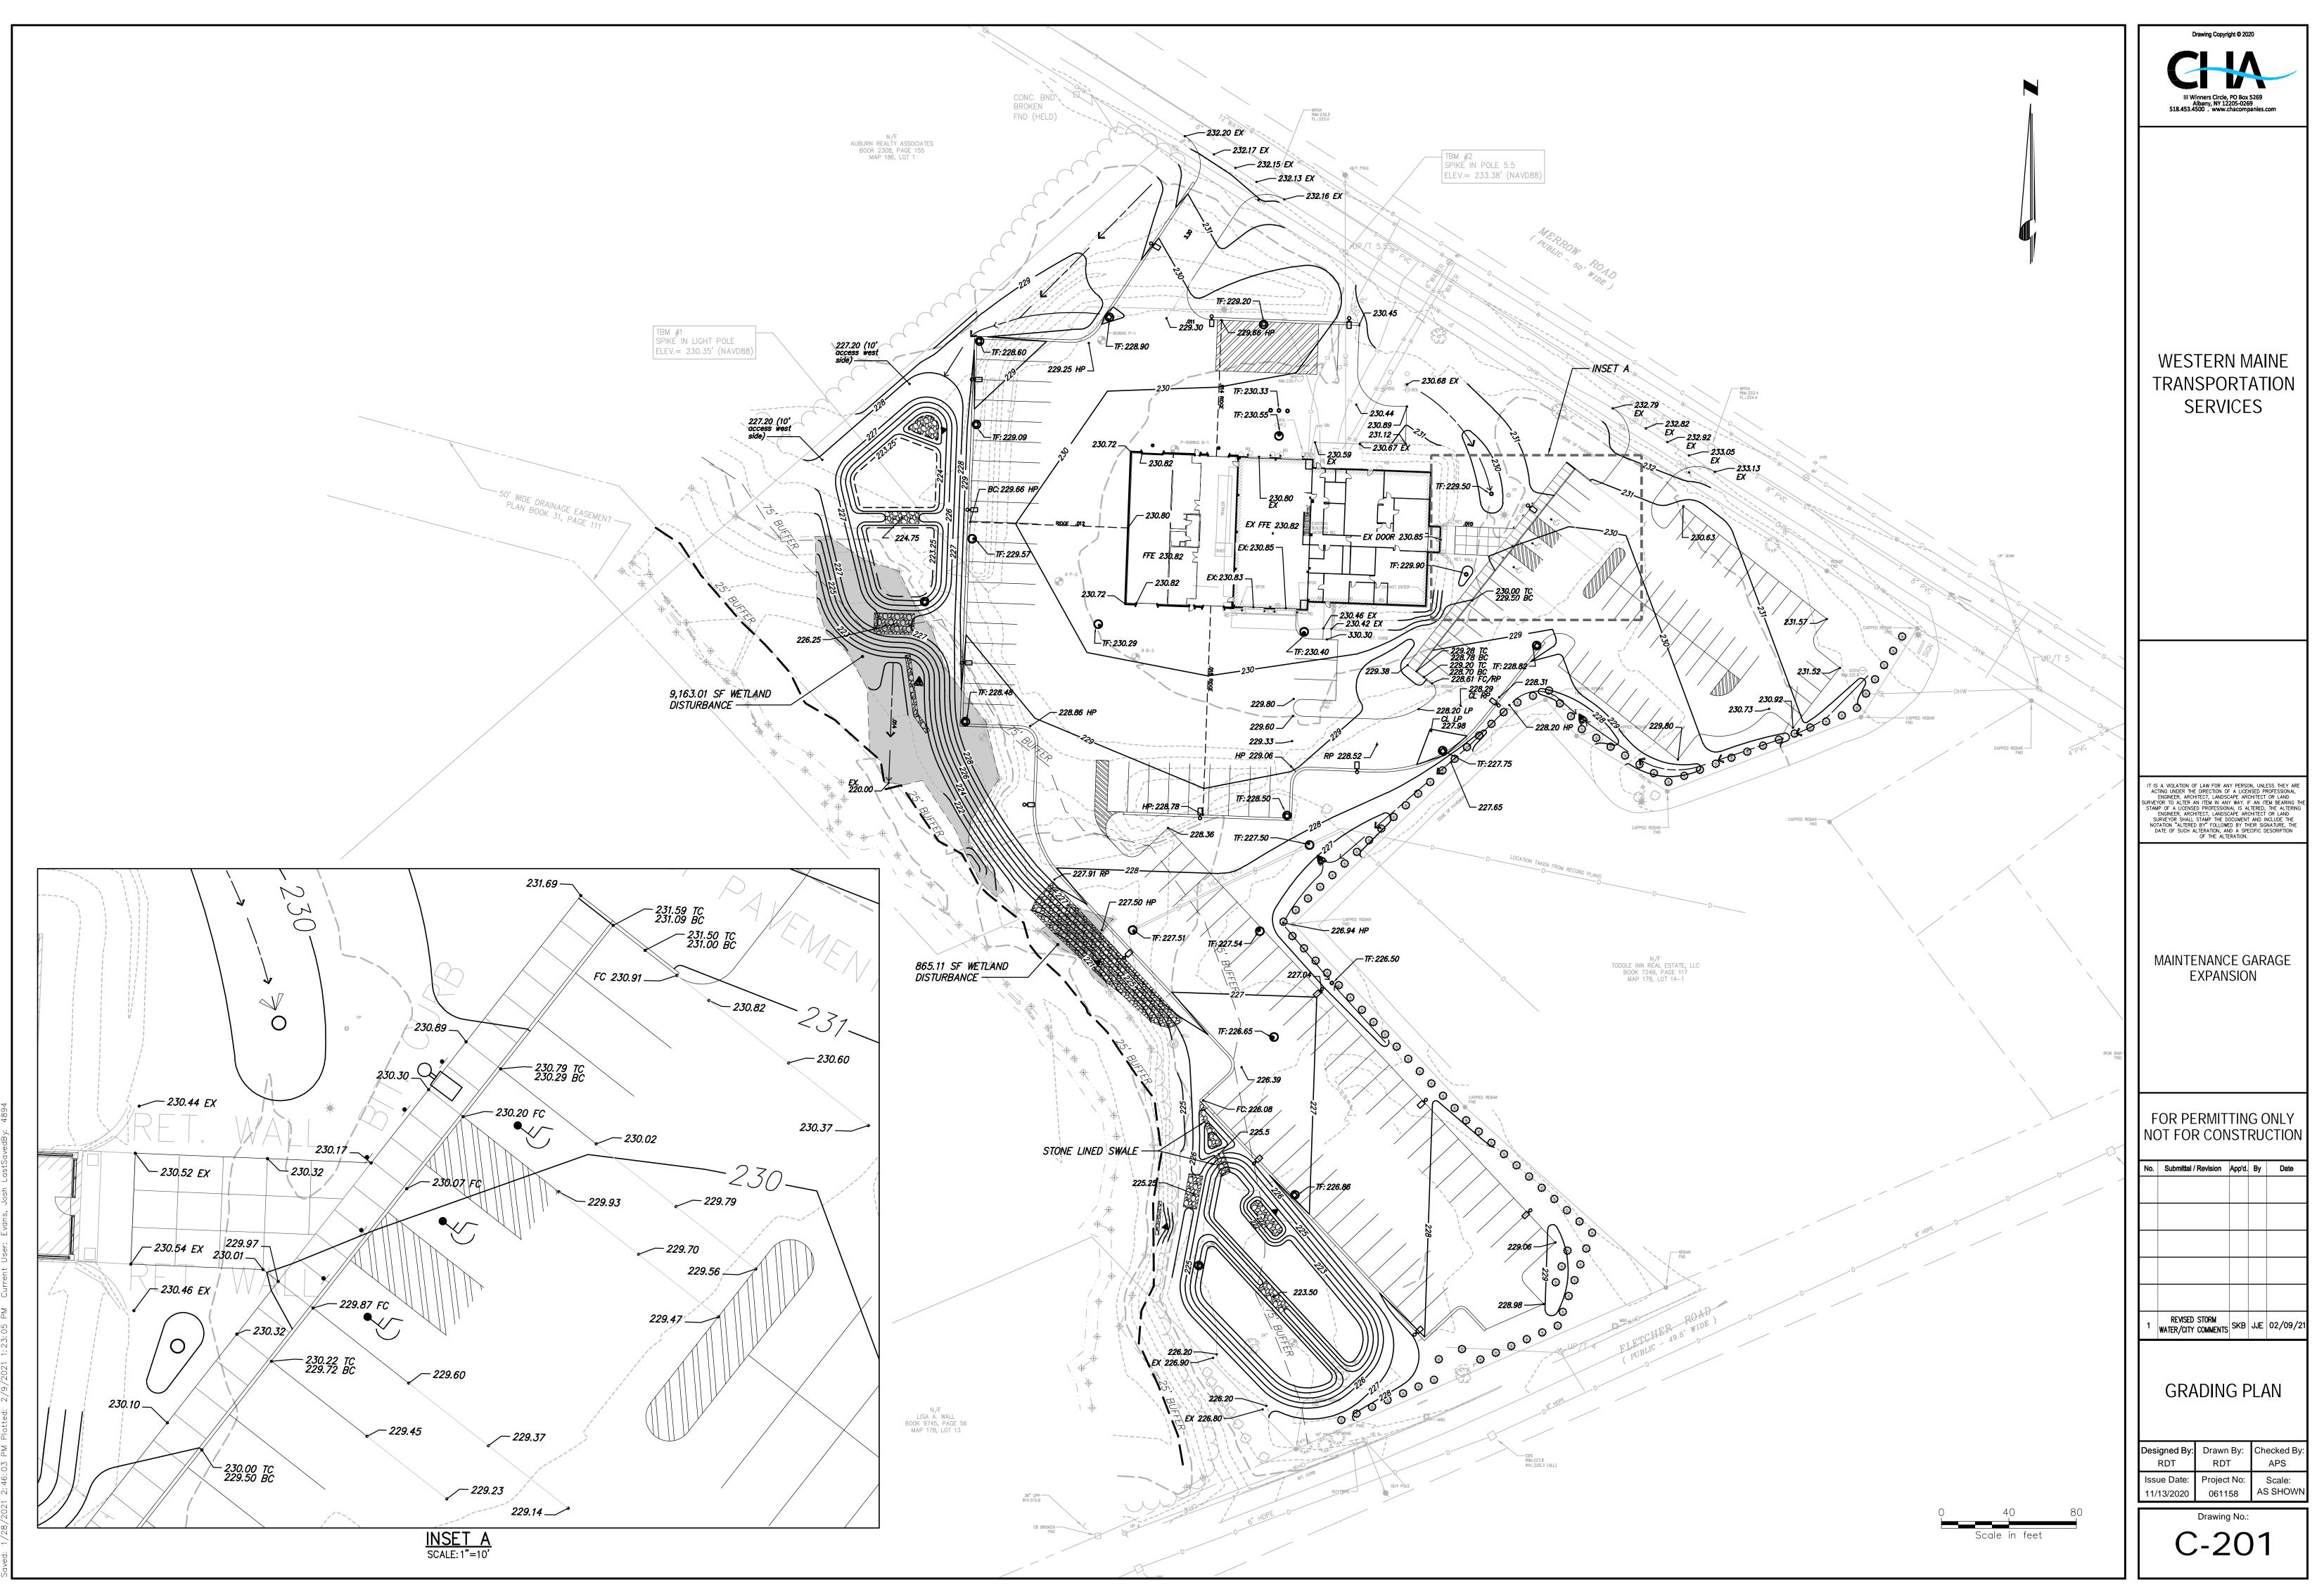


V:\PROJECTS\ANY\K5\061158.000\CADD_ACAD\061158_C-201.DWG 3d: 1/28/2021 2:46:03 PM Plotted: 2/9/2021 1:23:05 PM Current User: Evans, Josh LastSavedBy: 48

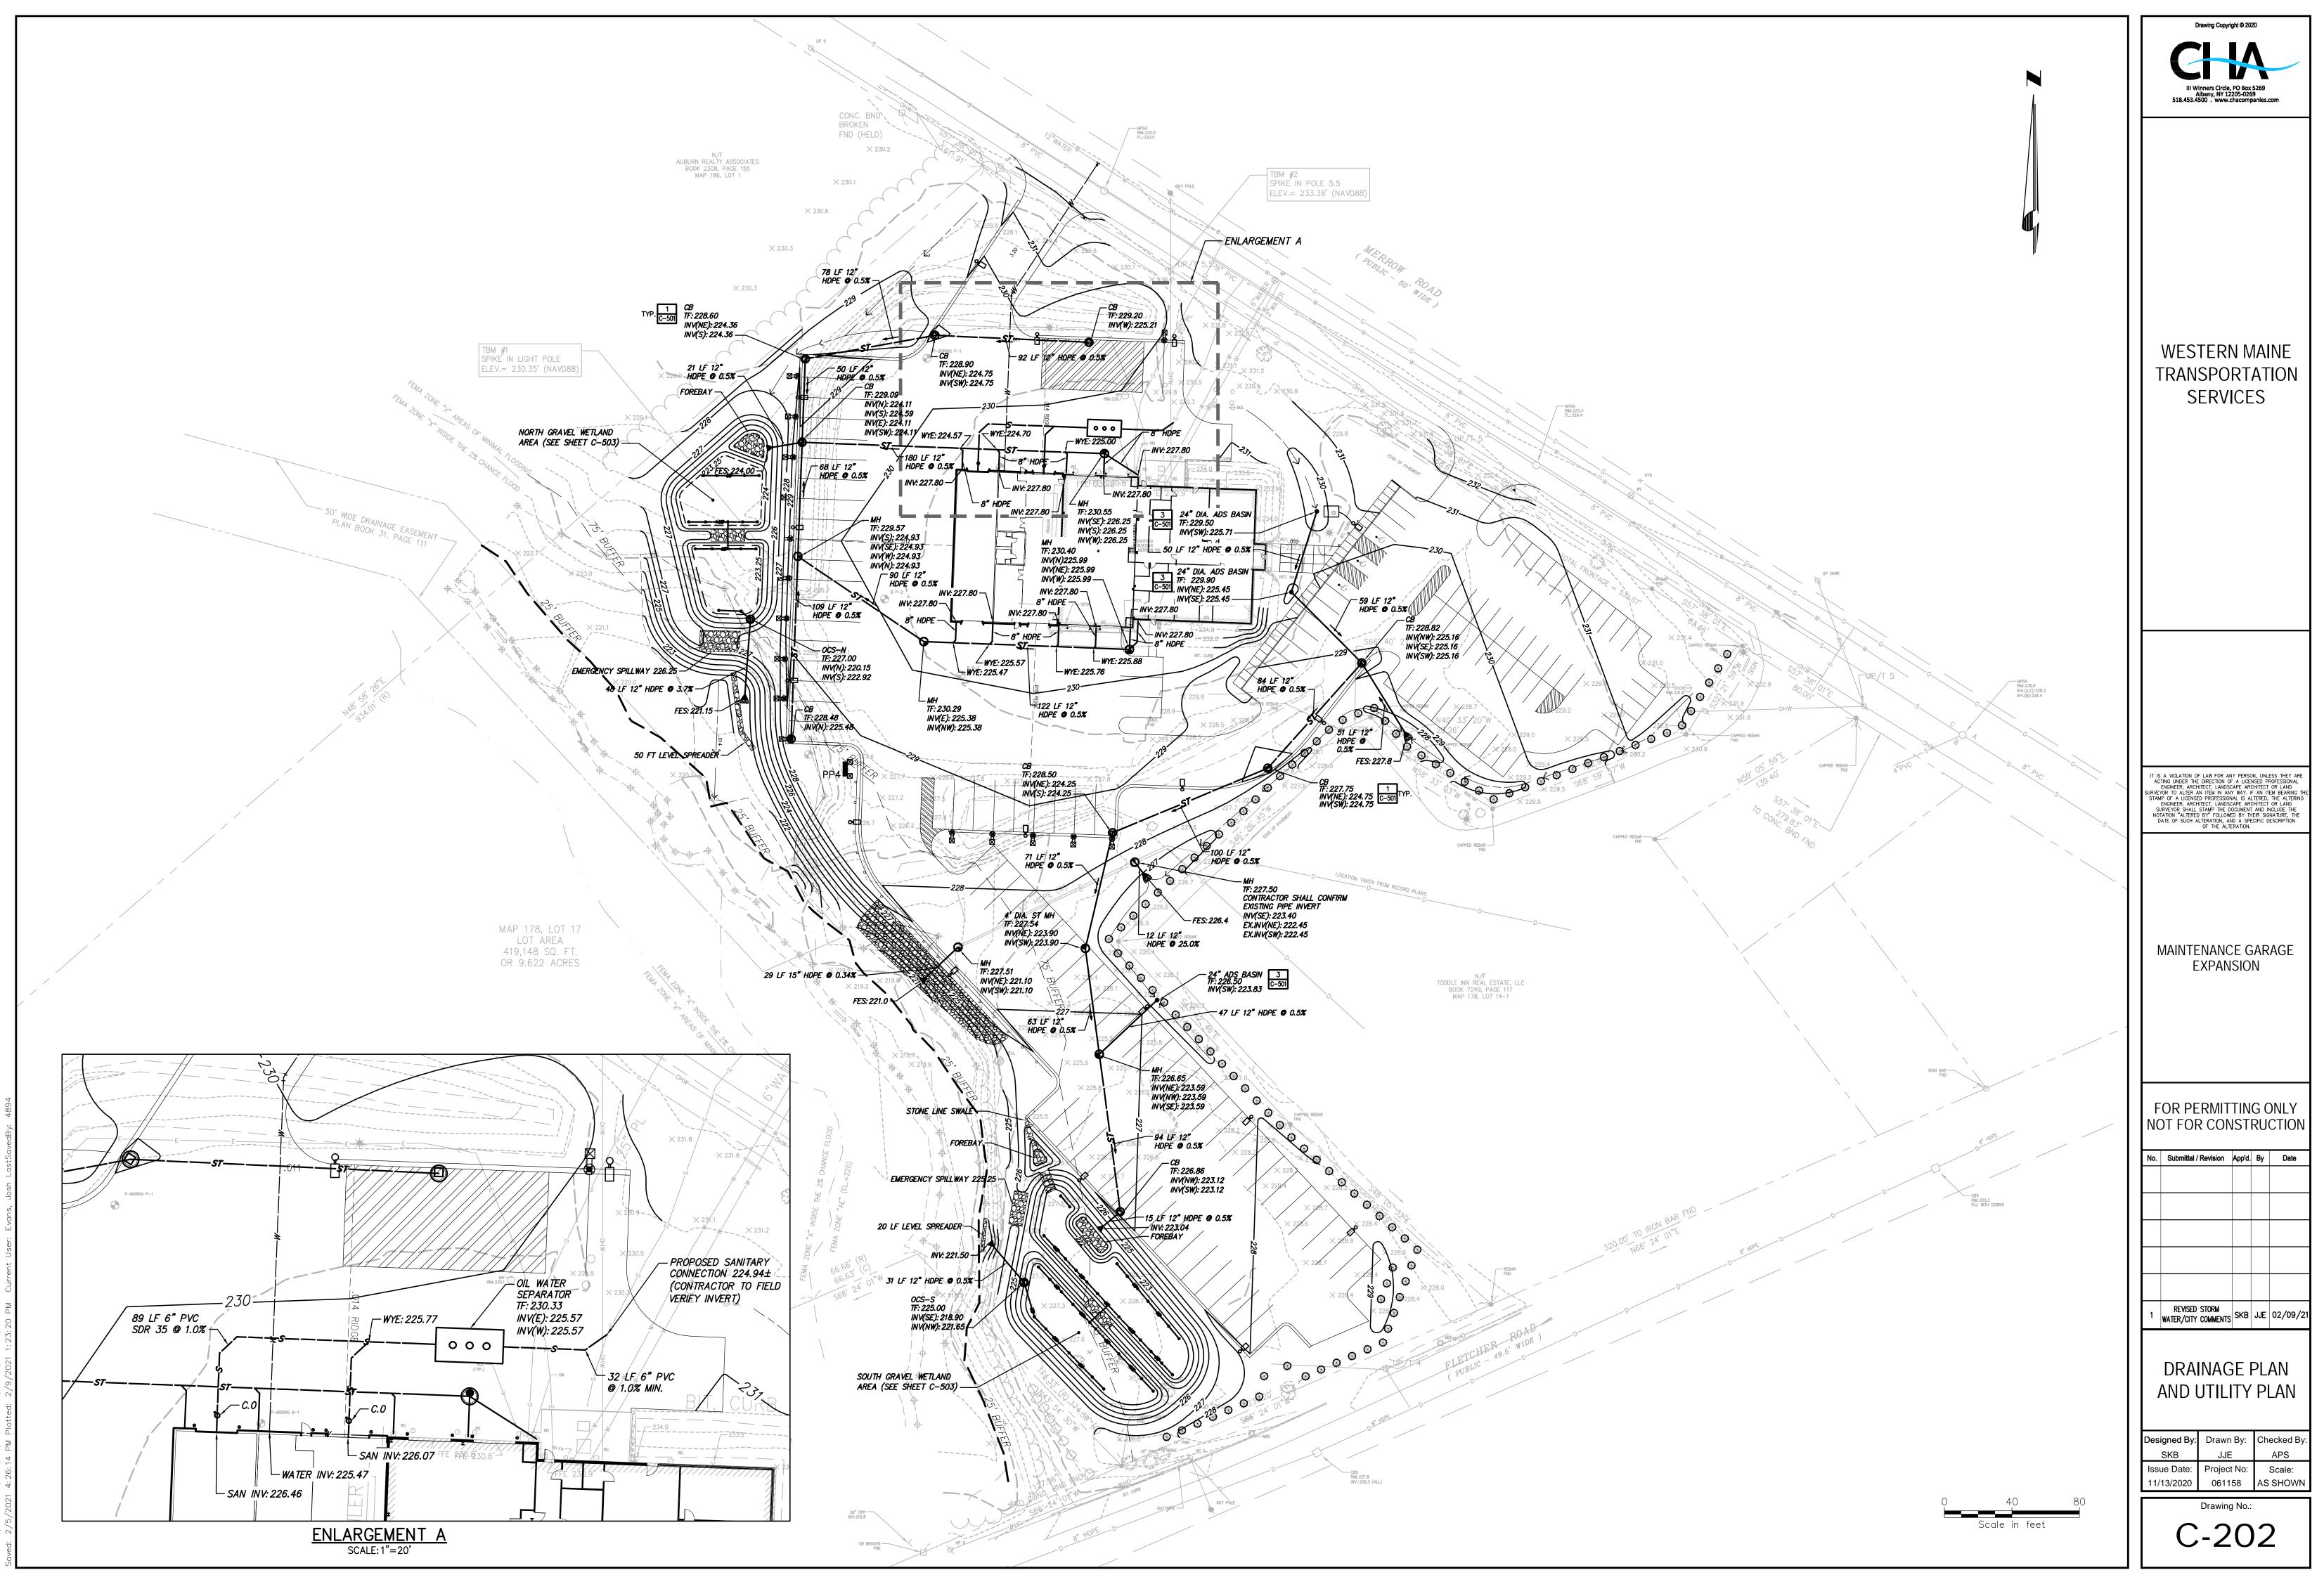


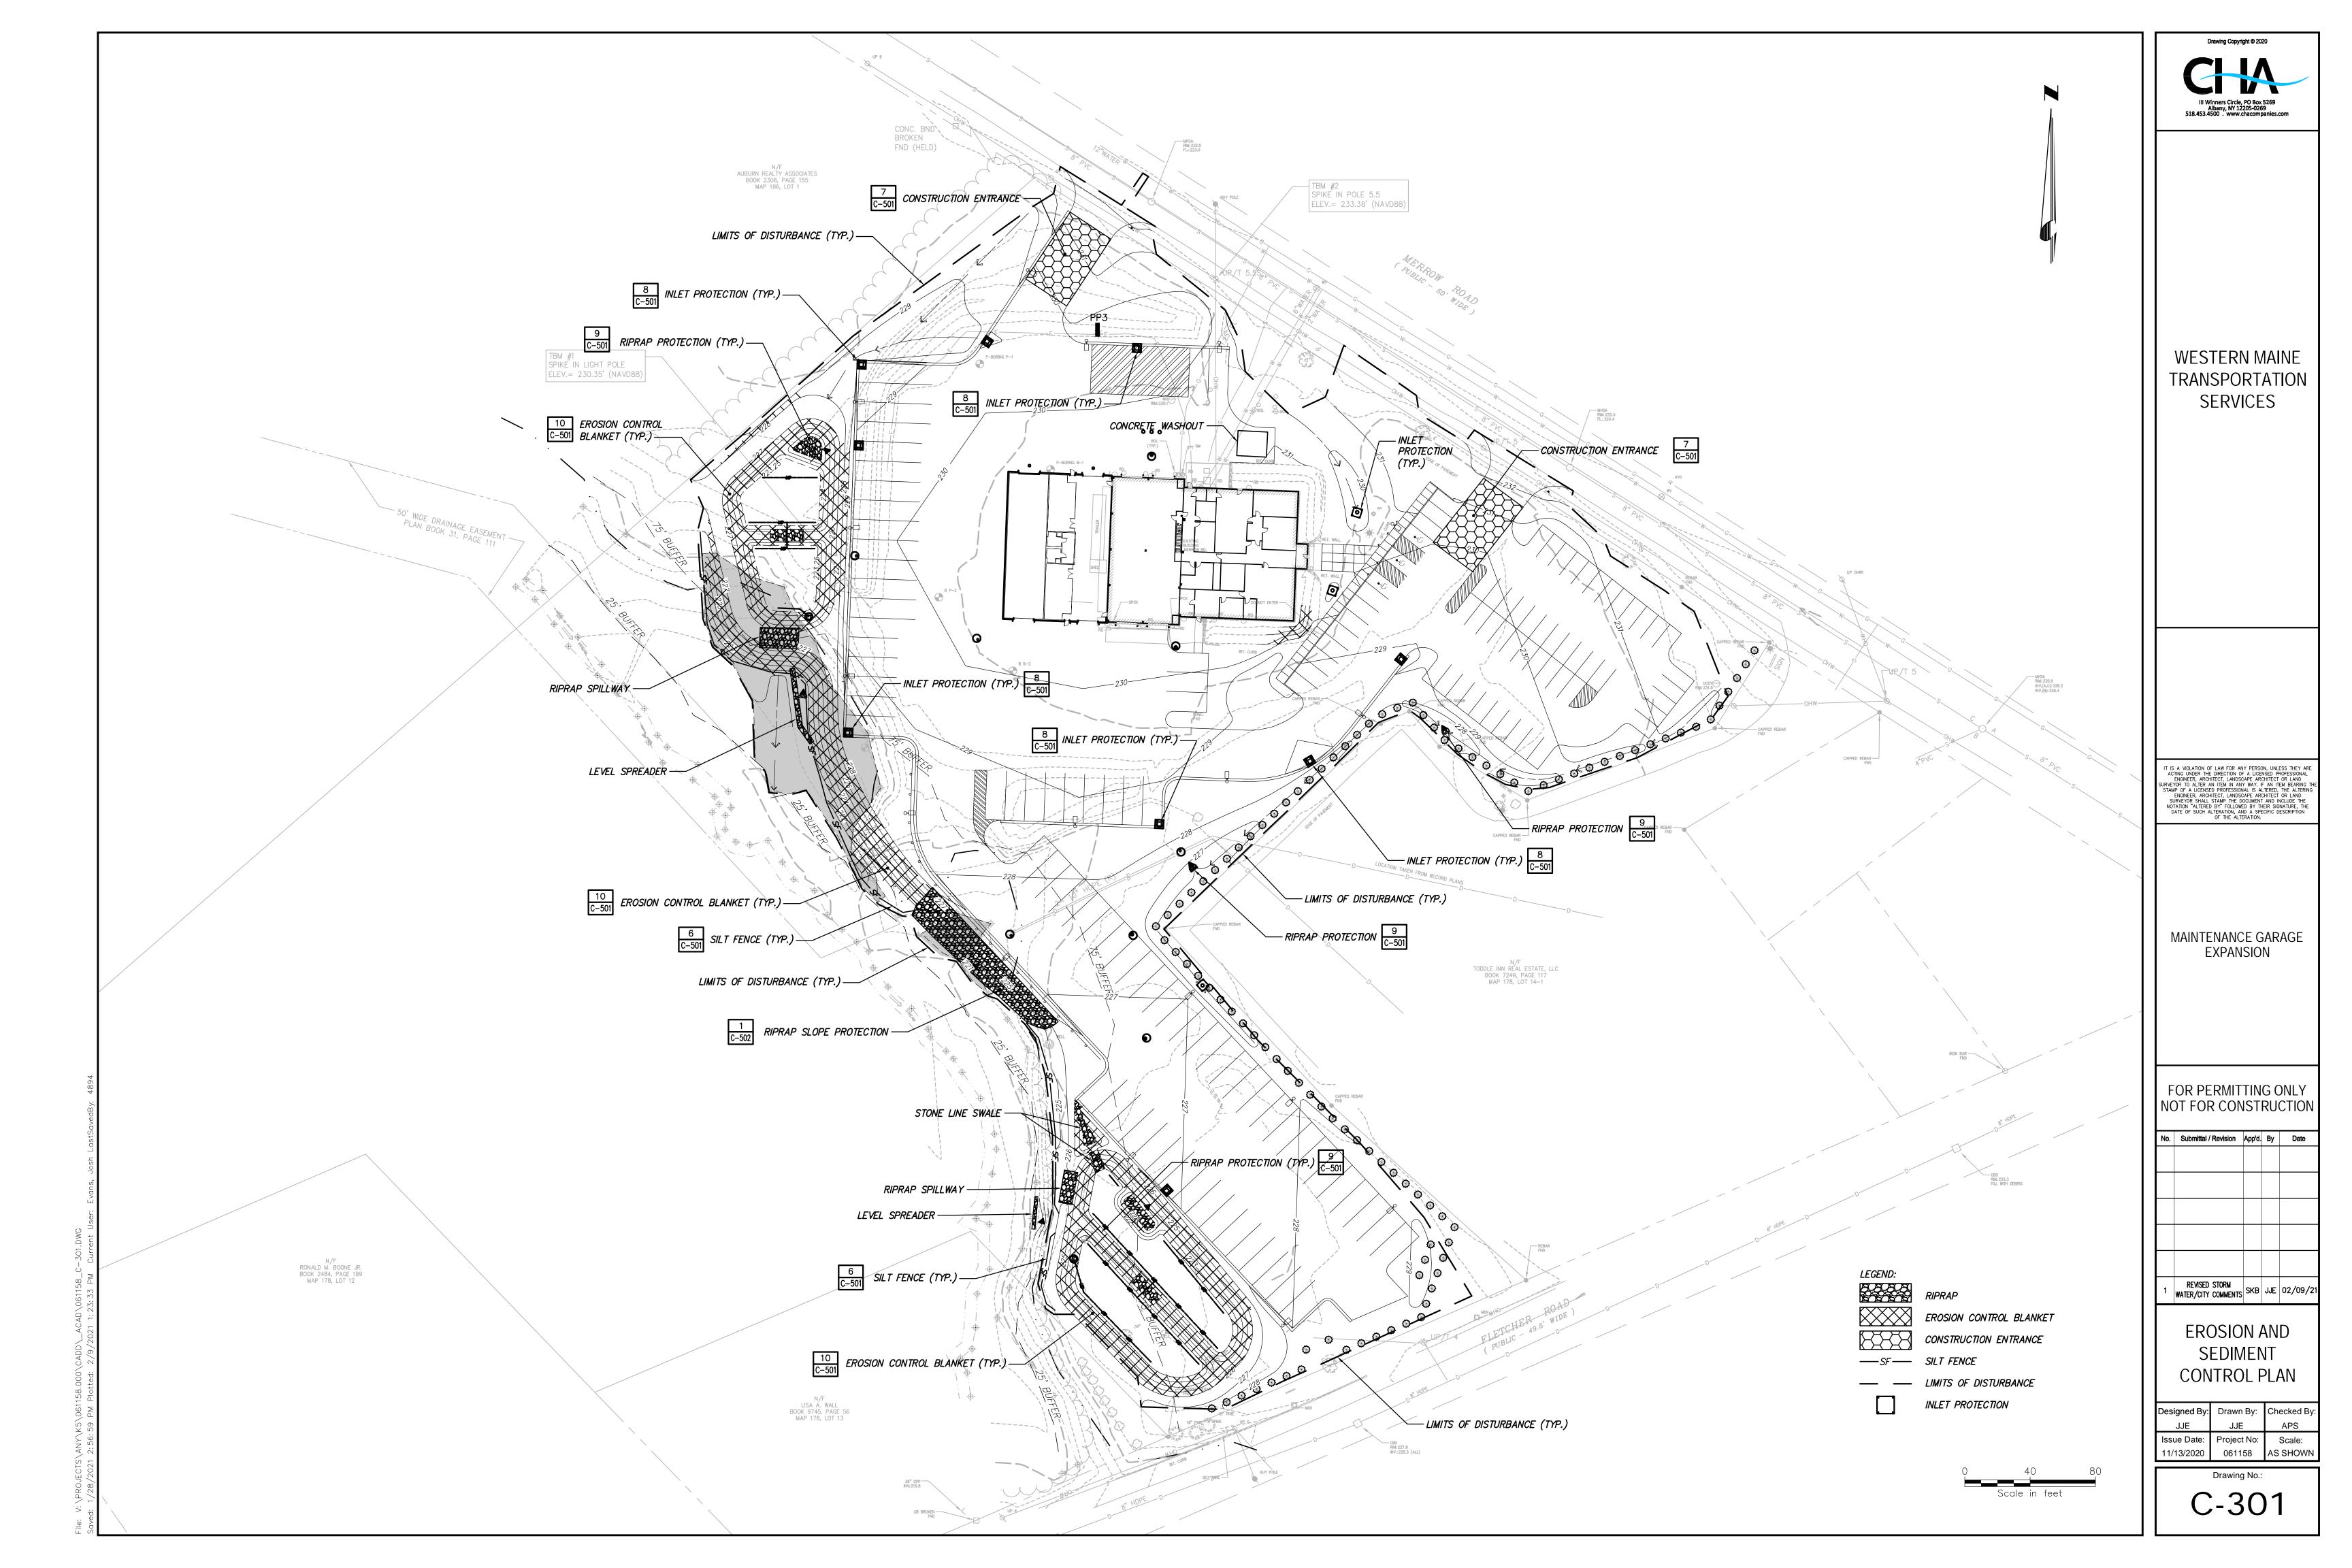


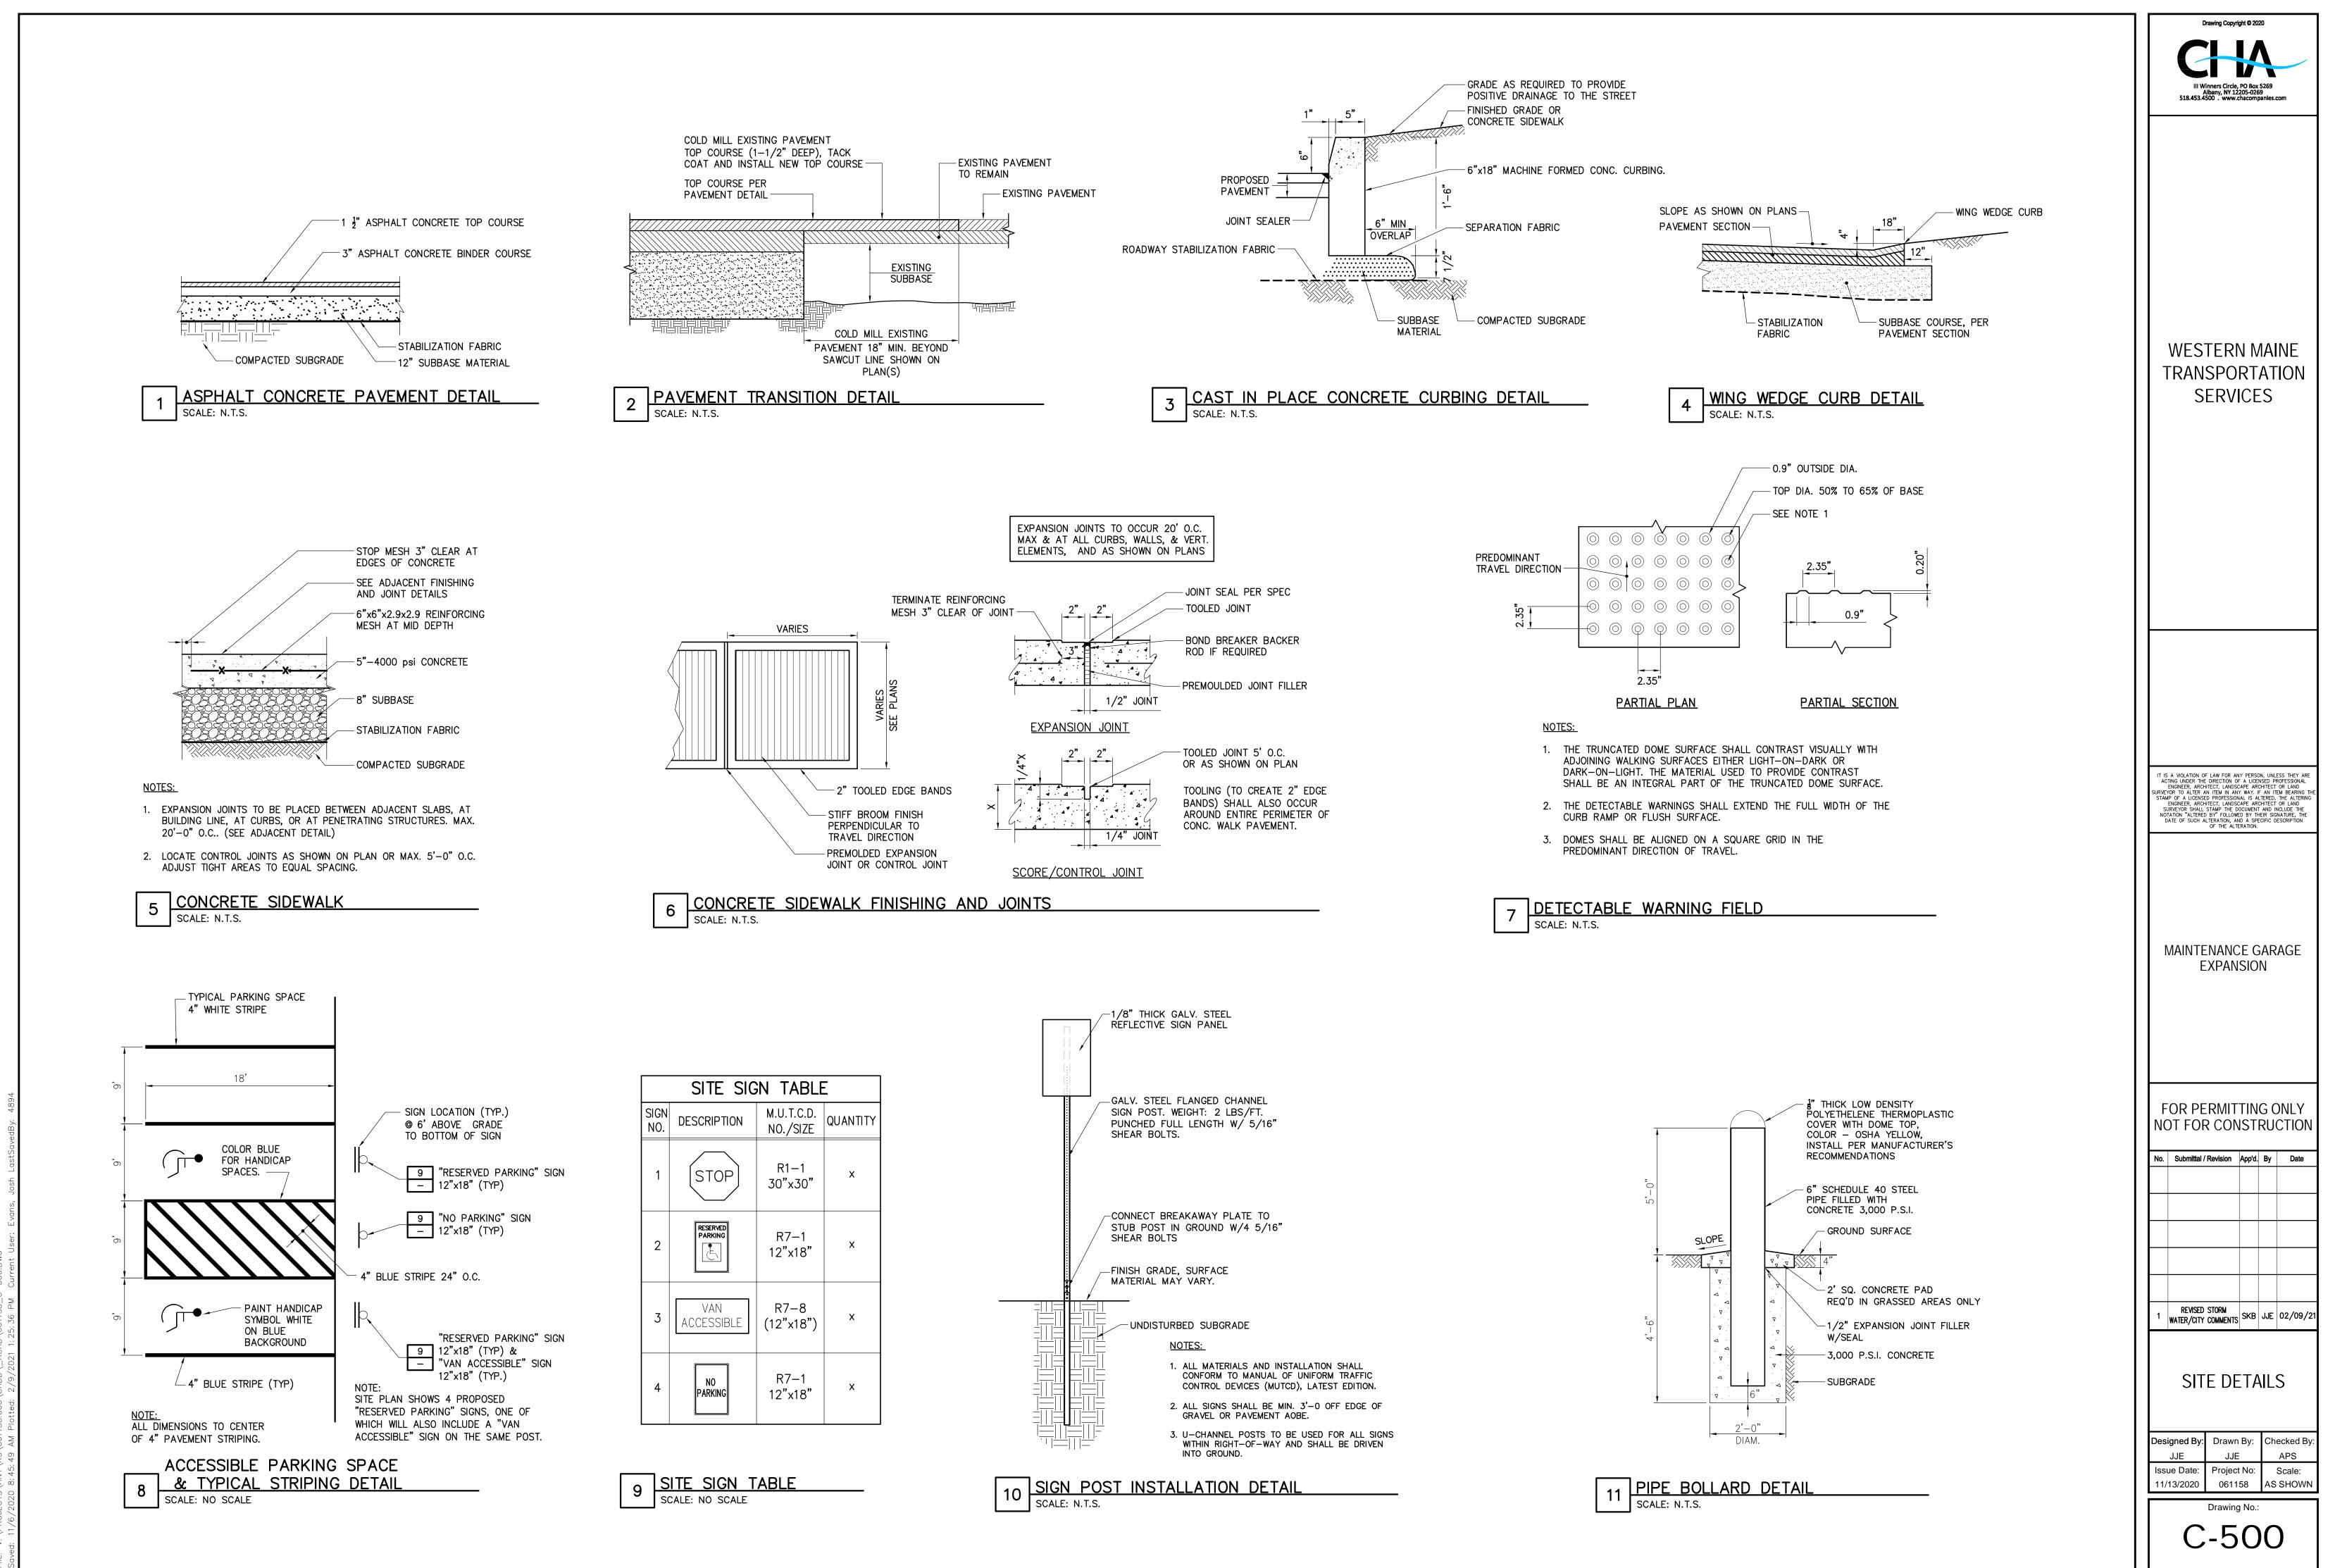


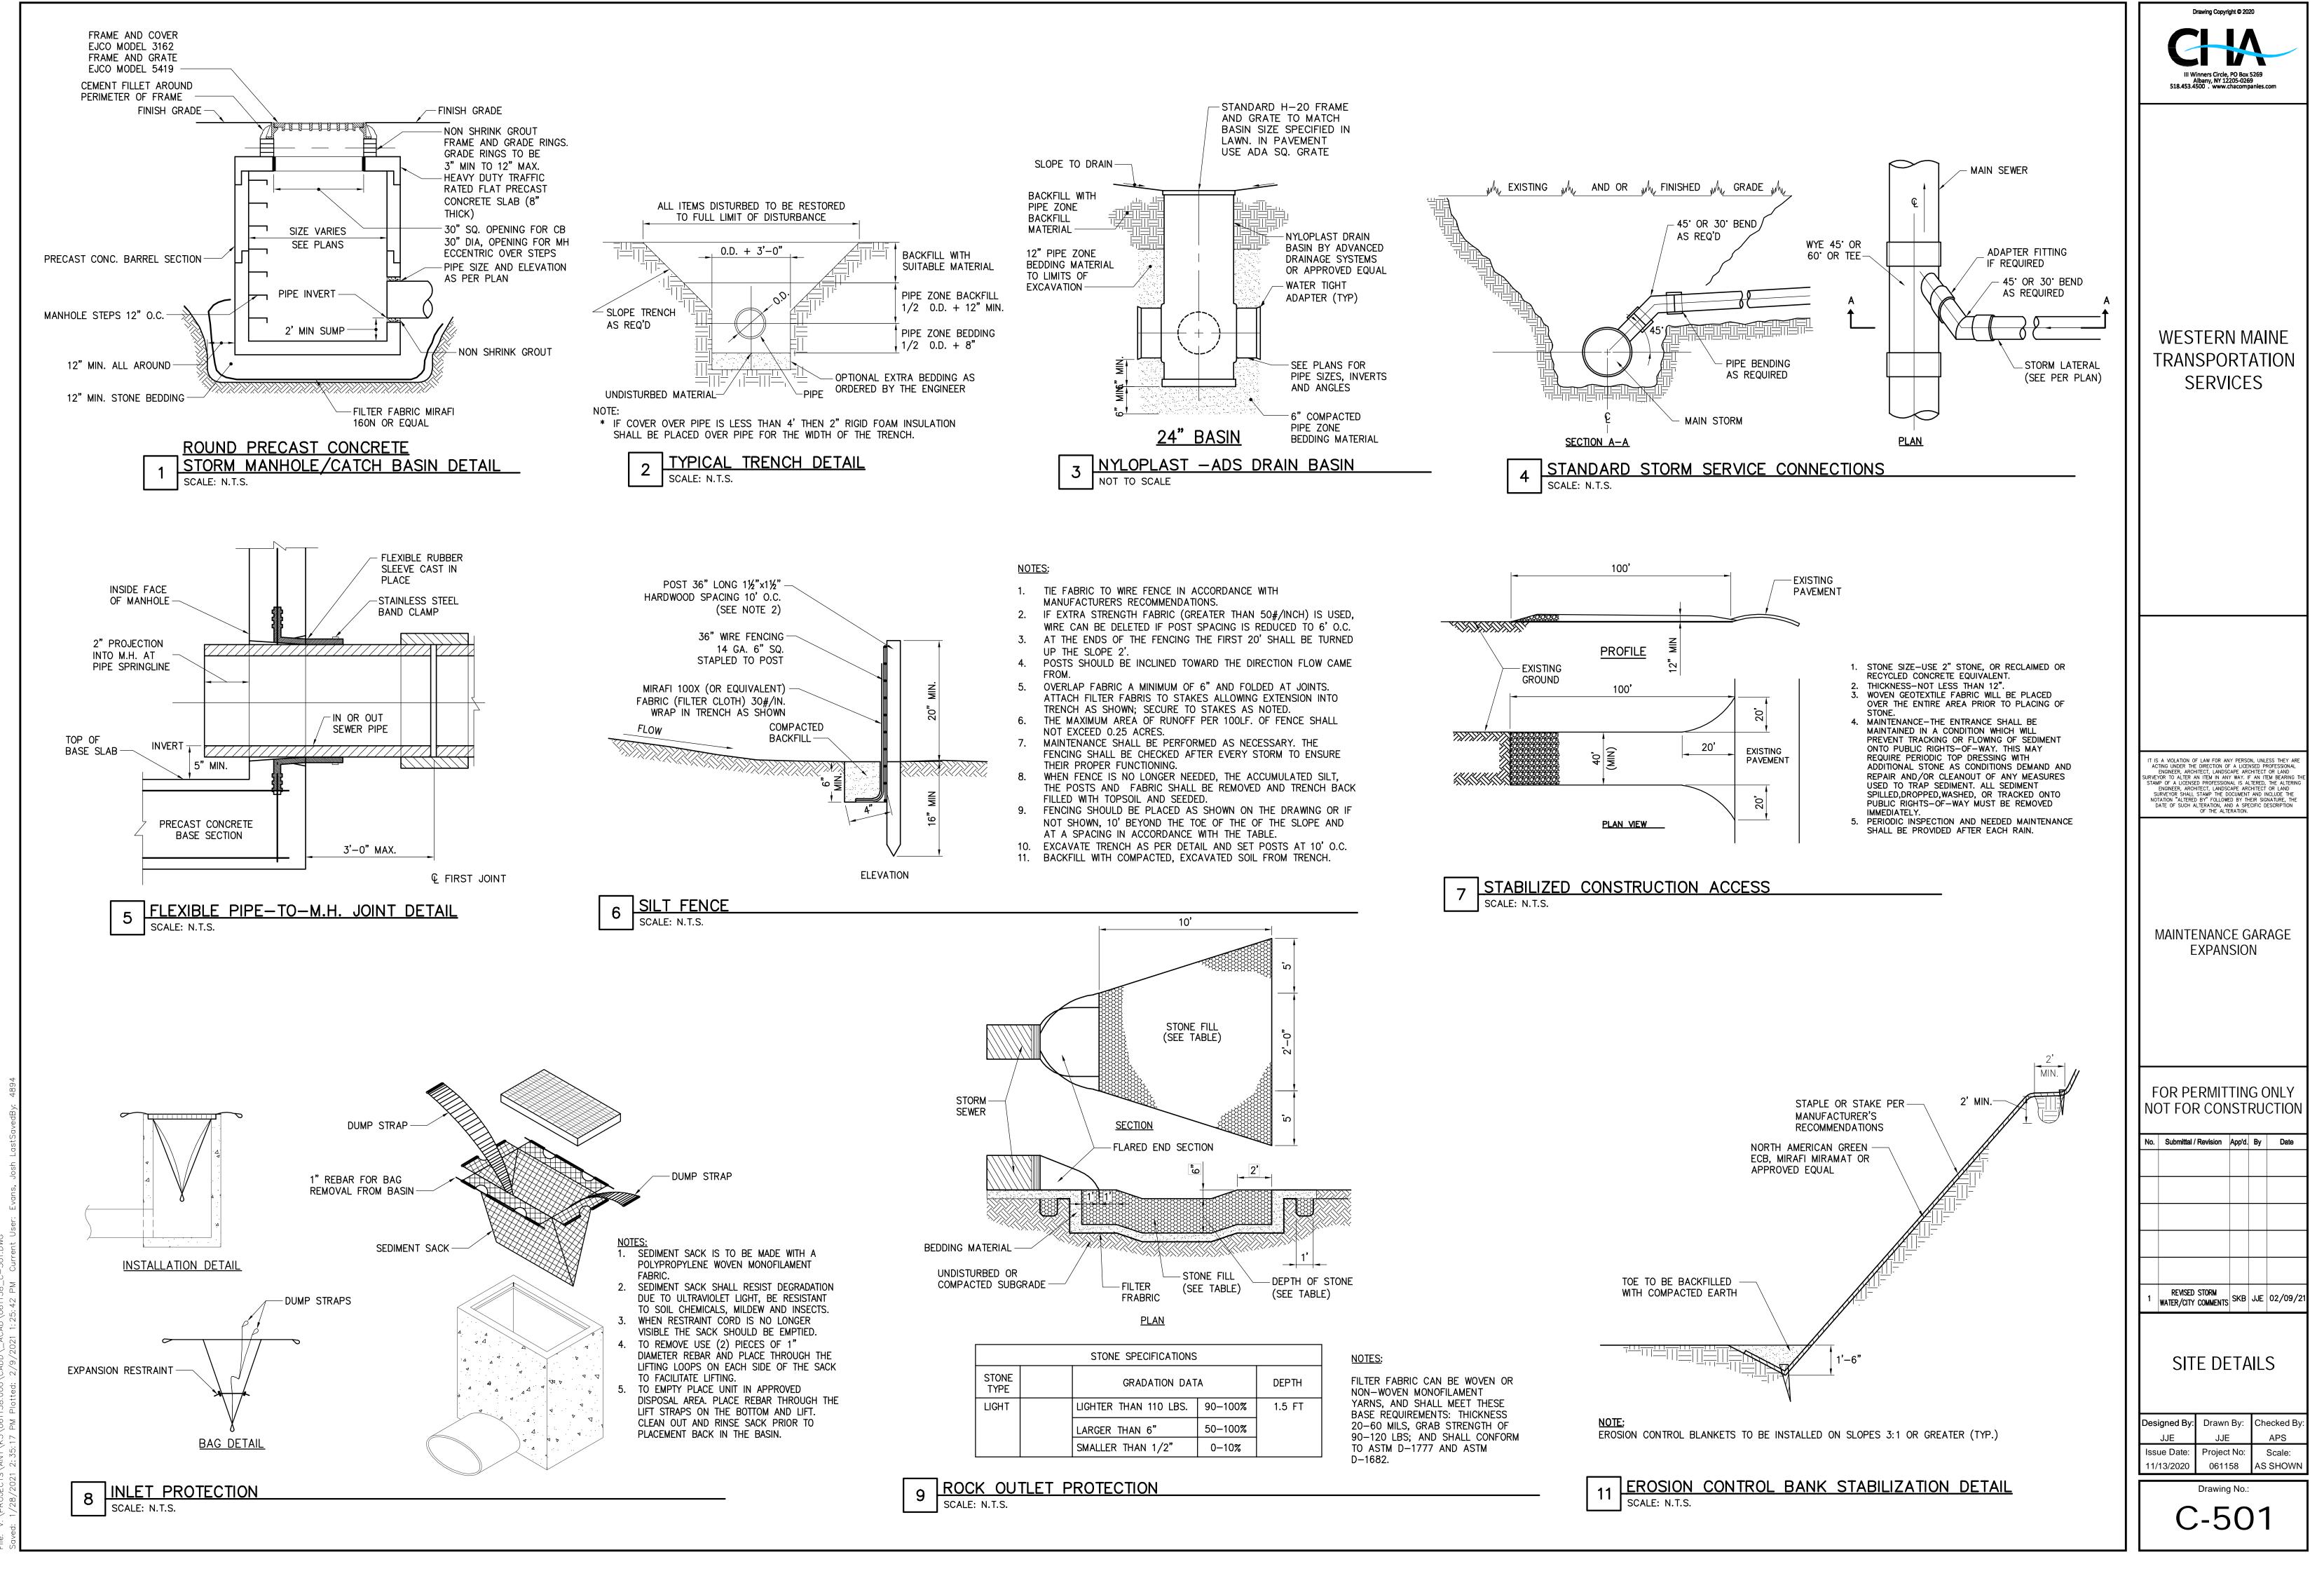

7	7	STABILIZED	CO
	/	SCALE: N.T.S.	

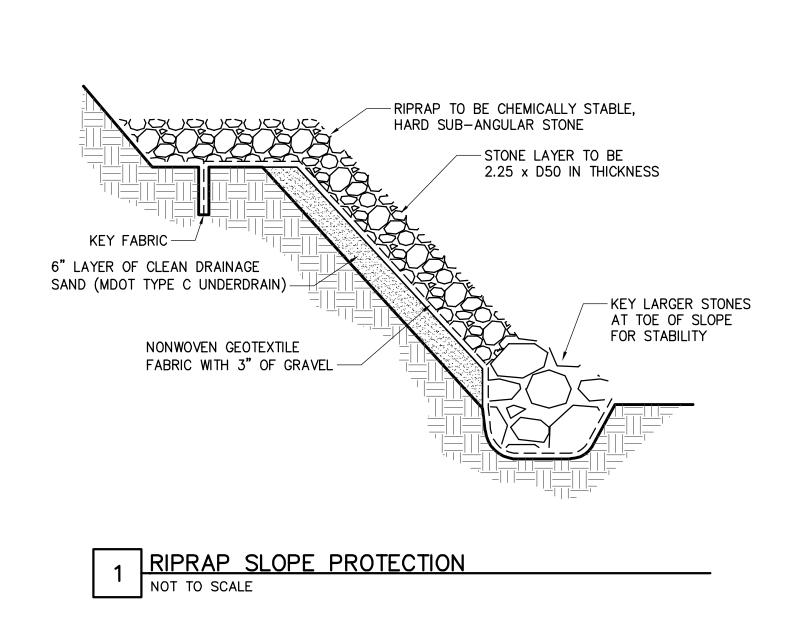

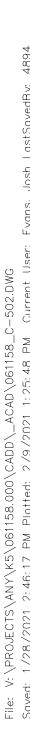

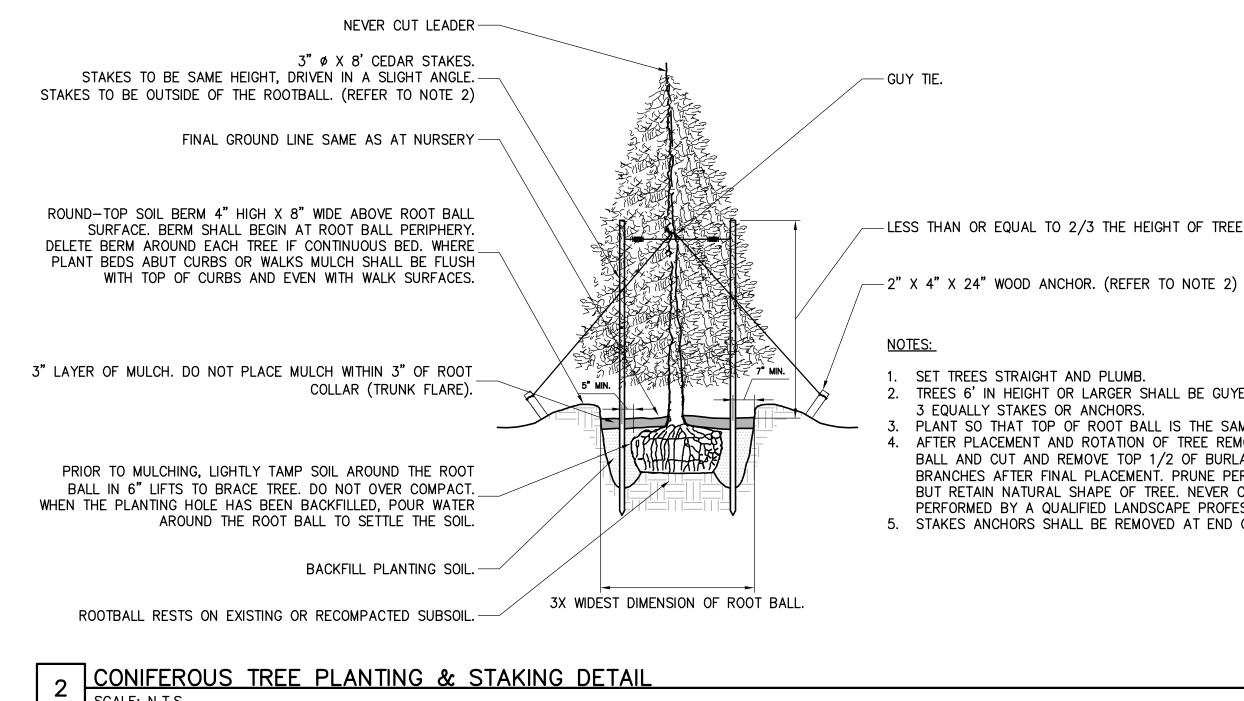


SCALE: N.T.S.

-LESS THAN OR EQUAL TO 2/3 THE HEIGHT OF TREE AT INSTALLATION.

2. TREES 6' IN HEIGHT OR LARGER SHALL BE GUYED AND STAKED/ANCHORED WITH 3. PLANT SO THAT TOP OF ROOT BALL IS THE SAME GRADE AS AT THE NURSERY. 4. AFTER PLACEMENT AND ROTATION OF TREE REMOVE ALL ROPES FROM ROOT BALL AND CUT AND REMOVE TOP 1/2 OF BURLAP. PRUNE ANY BROKEN BRANCHES AFTER FINAL PLACEMENT. PRUNE PERIMETER BRANCHES AS REQUIRED BUT RETAIN NATURAL SHAPE OF TREE. NEVER CUT A LEADER. PRUNING TO BE PERFORMED BY A QUALIFIED LANDSCAPE PROFESSIONAL. 5. STAKES ANCHORS SHALL BE REMOVED AT END OF MAINTENANCE PERIOD.



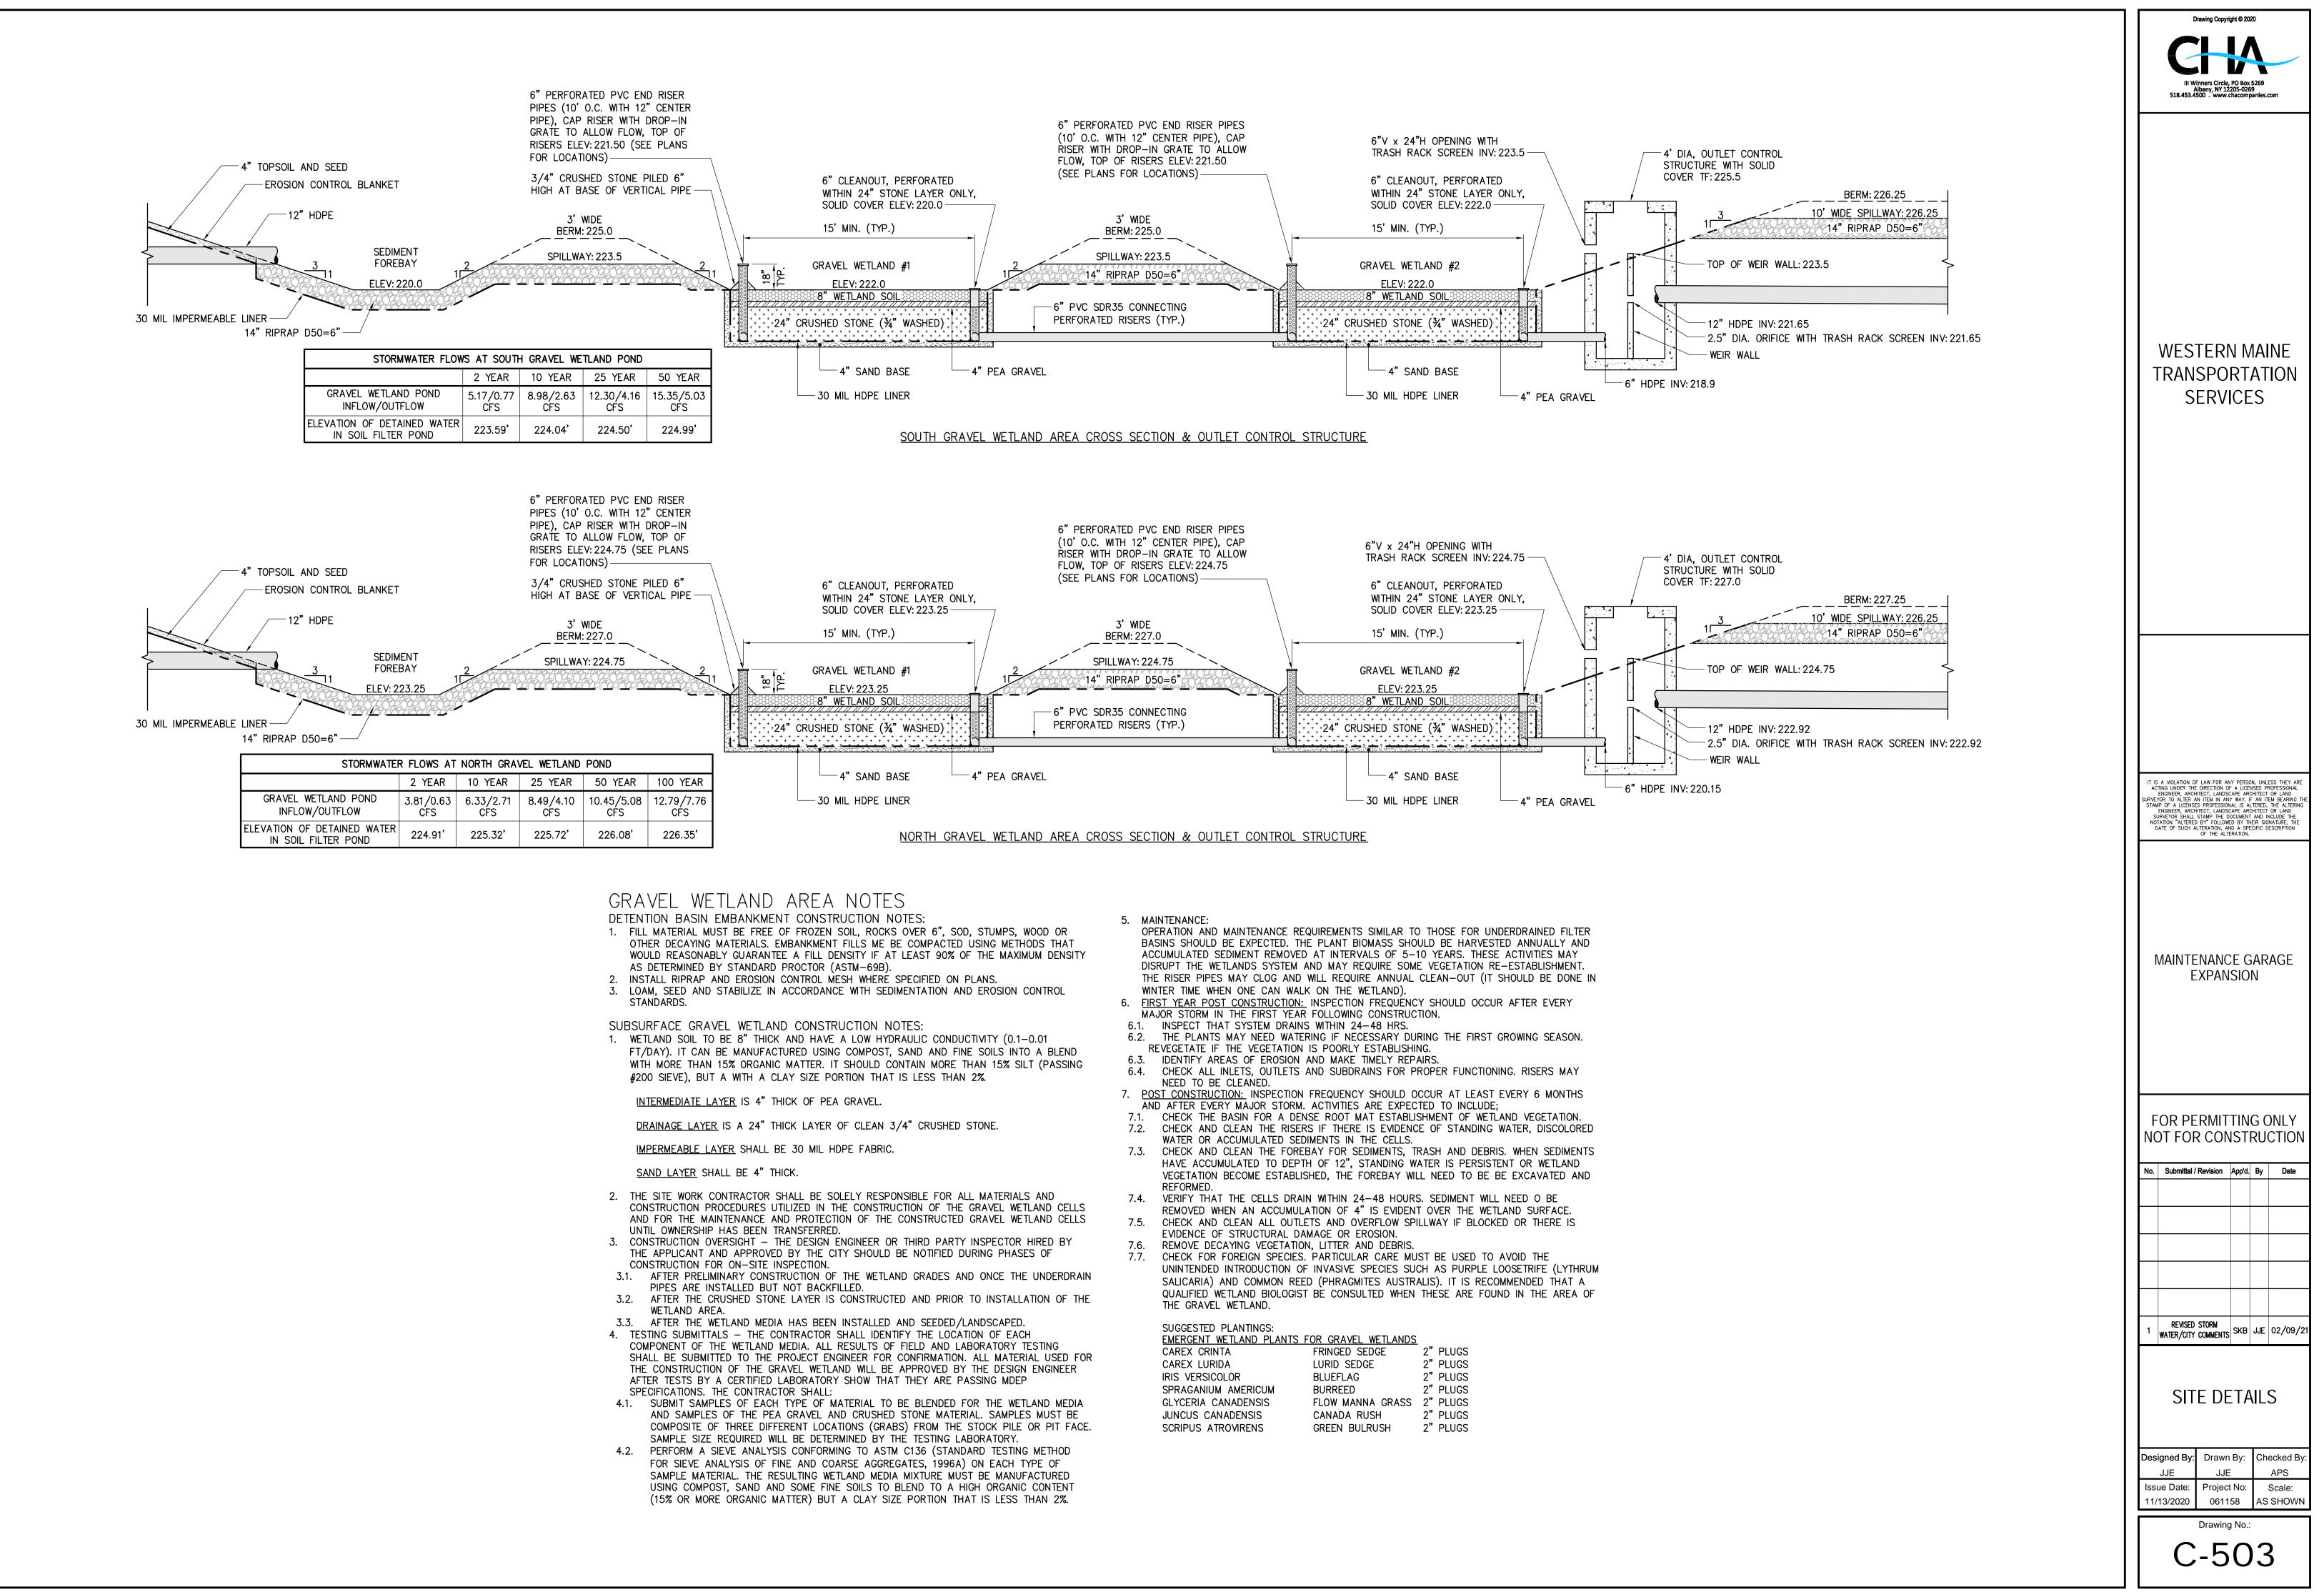

LIVILINGLINT WETLAND FLANTS I	UN GNAVLL WEILANDS	-
CAREX CRINTA	FRINGED SEDGE	2" PLUGS
CAREX LURIDA	LURID SEDGE	2"PLUGS
IRIS VERSICOLOR	BLUEFLAG	2"PLUGS
SPRAGANIUM AMERICUM	BURREED	2"PLUGS
GLYCERIA CANADENSIS	FLOW MANNA GRASS	2"PLUGS
JUNCUS CANADENSIS	CANADA RUSH	2"PLUGS
SCRIPUS ATROVIRENS	GREEN BULRUSH	2"PLUGS

